## IOWA DEPARTMENT OF NATURAL RESOURCES

# Construction Documents for Beach Concession Building Remodel Lake Manawa State Park

Pottawattamie County, IA PROJECT #23-04-78-02


PLANS PREPARED BY


LAND AND WATERS BUREAU

CONSERVATION AND RECREATION DIVISION

/	DIREC	TORY				
OWNER		DISTRICT INSPECTOR				
COMPANY	IOWA DEPARTMENT OF NATURAL RESOURCES	COMPANY	IOWA DEPARTMENT OF NATURAL RESOURCES			
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ARCHITECT		_				
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PROJECT DESCRIPTION		AUTHORIZATION TO BID		
Lake Manawa State Park has a very popular beach area and a concession building adjacent to the beach. This concession building was constructed in the mid—1980s and is in need of a refresh. This project will remodel the Beach Concession Building restrooms and replace some items on the exterior of the building which are rotting. The restrooms will receive all new toilet partitions, new lavatories and countertops, new restroom accessories, changing tables, and new interior lighting. The exterior of the concession building will get a new coiling door over the existing window wall, new gutters, soffits, and fascia around the entire building. The contractor shall replace light heads on the existing site light poles, poles shall be painted.				
		BC - LAND AND WATERS	DATE	
				_
	$\mathcal{I} \setminus$	AUTHORIZED - PARKS   WILDLIFE   FISHERIES   LAW ENFORCEMENT	DATE	



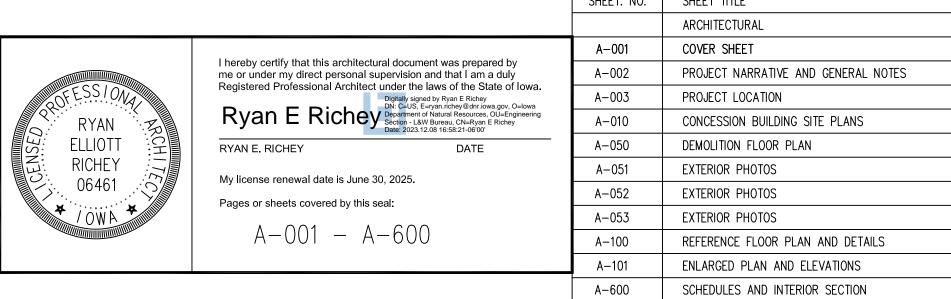

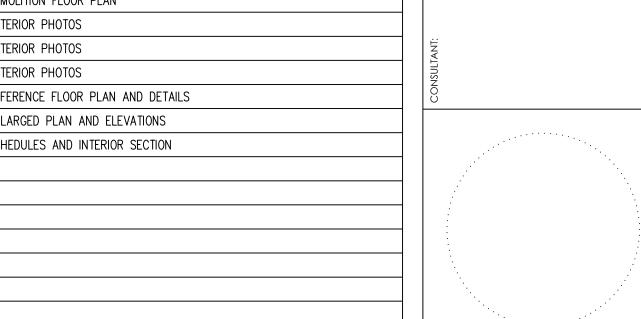SHEET INDEX

BID ITEMS

ITEM DESCRIPTION

MOBILIZATION

5 OVERHEAD COILING DOOR

6 | WASH AND SEAL EXTERIOR CMU

9 URINAL AND ALL ACCESSORIES

ELECTRICAL BOX REPAIR

DEMOLITION AND SALVAGE

POLE LIGHT BLASTING AND POWDER COATING

4 LED POLE LIGHT HEADS AND REINSTALLATION

SOFFIT, FASCIA, AND GUTTER REPLACEMENT


8 TOILET PARTITIONS AND RESTROOM ACCESSORIES

LAVATORY COUNTERS, SINKS, AND FAUCETS

RESTROOM LIGHT FIXTURE REPLACEMENT

CONCESSION COUNTERTOP REPLACEMENT

INTERIOR WASHING AND PAINTING

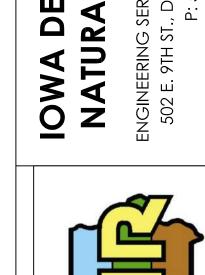

COVER SHEET

Beach Concession Building Remodel for:

ake Manawa State Park

QUANTITY

LUMP SUM

4 EA 4 EA

1 EA

210 LF

1 EA

10 EA

LUMP SUM

DRAWN BY: PROJECT NUMBER:
23-04-78-02
CHK'D BY: DATE:
12.19.2023
SHEET NO:

**A-001** 

- WHEN A ROOM CENTERLINE IS INDICATED ONLY ONE SIDE OF THE ROOMS ELEMENTS MAY BE DIMENSIONED.

"EQUAL OR EQ" IS USED IN LIEU OF THE ACTUAL DIMENSIONS.


IN INTERIOR SPACES THE ACTUAL DIMENSIONS MAY BE LESS IMPORTANT THAN IF AT

TWO ELEMENTS IN THE BUILDING WERE TO BE EQUAL. IN THESE CASES, THE WORD

- COLUMN IDENTIFICATION: DETAILS WILL GOVERN ALL DIMENSIONS AND NO DIMENSIONS
- WILL BE SHOWN ON SMALL SCALE PLANS.
- PARTITION CENTERED ON COLUMN OR GRID LINES WILL NOT BE DIMENSIONED ON SMALL SCALE PLANS.
- PARTITION WITH A FINISHED FACE FLUSH WITH FINISH FACE OF COLUMN WILL NOT be DIMENSIONED ON SMALL SCALE PLANS.
- PARTITION FINISH FACE ON COLUMN OR GRID LINE WILL NOT BE DIMENSIONED ON SMALL SCALE PLANS
- WHEN ONE JAMB OCCURS AT A COLUMN OR GRID LINE NO DIMENSIONS WILL BE SHOWN ON THE SMALL SCALE PLANS. THE OPENING WIDTH WILL BE GOVERNED BY CRITERIA OR SCHEDULES.
- WHEN NEITHER JAMB OCCURS AT A COLUMN OR GRID LINE ONE JAMB WILL BE
- DOOR LOCATIONS ARE TO BE LOCATED BY ONE OF FOLLOWING:
- a. ONE JAMB FACE LOCATED BY A PARTITION AT RIGHT ANGLE. 4"TYPICAL UNLESS INDICATED ON PLAN.
- b. OR AS DIMENSIONED ON PLAN.
- 10. PARTITIONS ARE DIMENSIONED TO FACE OF CMU OR FACE OF STUD UNLESS

11. DIMENSIONS ARE INDICATED IN THE DOCUMENTS. THE DRAWINGS SHALL NOT BE SCALED FOR DIMENSIONS.

## MATERIAL LEGEND CONCRETE MASONRY UNIT GYPSUM / STUCCO CONCRETE COMPACTED EARTH metal stud grout PARTICLE BOARD ASPHALT GRAVEL cast stone \_\_\_\_\_ PLYWOOD foam INSULATION BATT INSULATION RIGID INSULATION fence ACOUSTICAL CEILING TILE STEEL WOOD BLOCKING шшш FINISHED WOOD CONTINUOUS WOOd

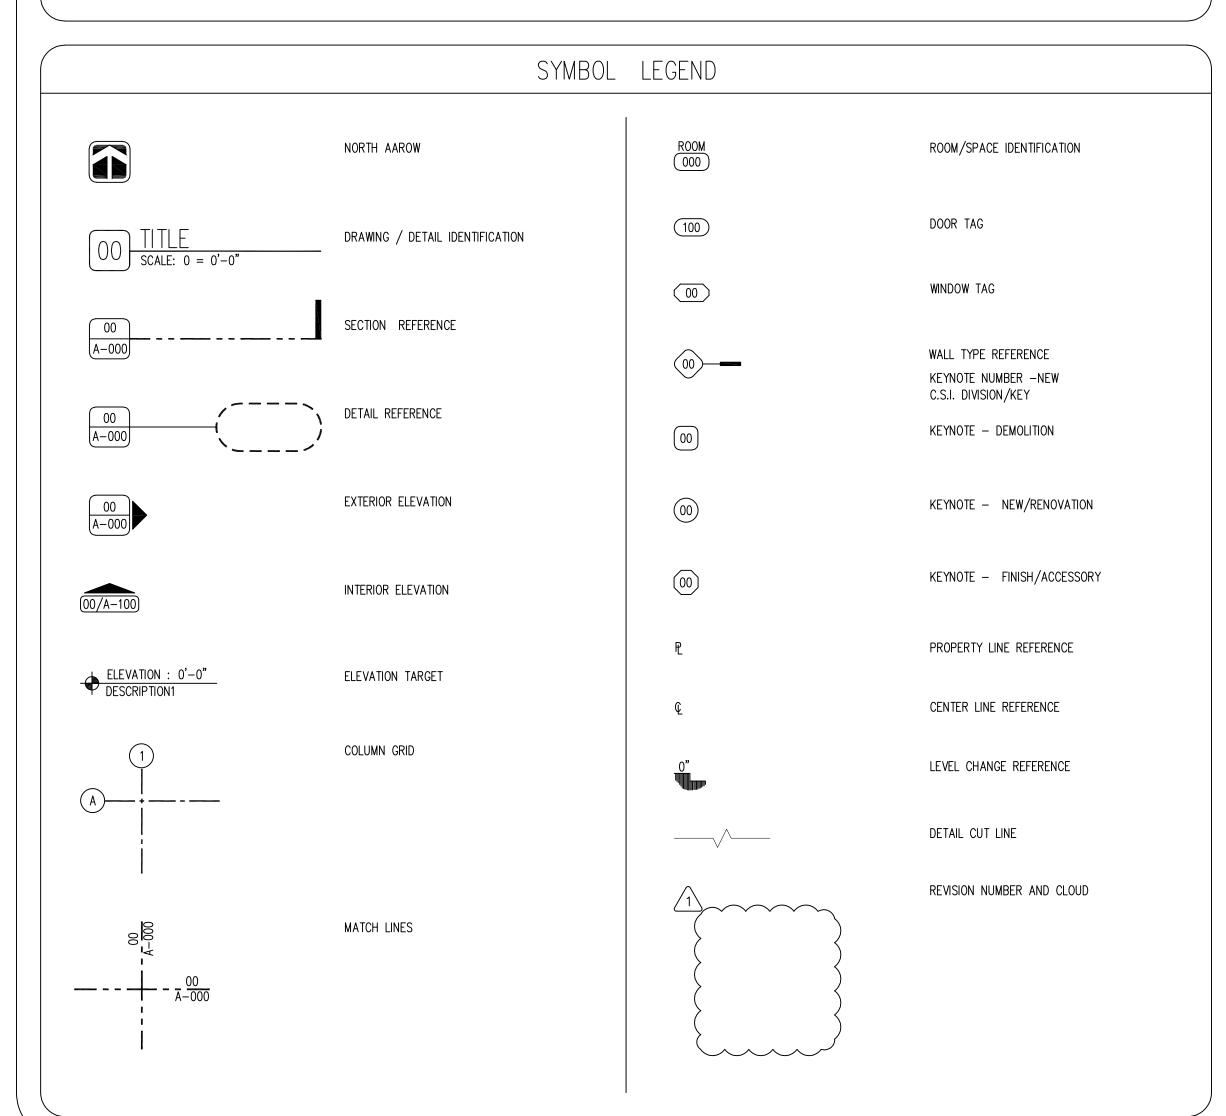

GENERAL NOTES

THE FOLLOWING GENERAL NOTES SHALL PERTAIN TO THE ENTIRE SET OF CONTRACT DOCUMENTS

- A GENERAL CONTRACTOR SHALL NOTE THAT THE ARCHITECTURAL DRAWINGS ARE ESTABLISHING A MINIMUM MATERIAL OR CONSTRUCTION METHOD STANDARD. THE GENERAL CONTRACTOR SHALL PROVIDE A BID PRICE BASED ON THE SPECIFIC MATERIALS NOTED. DO NOT SCALE DRAWINGS. IF DIMENSIONS ARE IN QUESTION, THE CONTRACTOR SHALL BE RESPONSIBLE FOR
- OBTAINING CLARIFICATION FROM THE ARCHITECT BEFORE CONTINUING WITH CONSTRUCTION.
- GENERAL CONTRACTOR AND SUBCONTRACTORS SHALL PERFORM THEIR WORK IN ACCORDANCE WITH ALL APPLICABLE CODES GOVERNING EACH TRADE.
- THE CONTRACTOR SHALL MAINTAIN A CLEAN AND ORGANIZED JOB SITE, ACCEPTABLE TO THE OWNER.
- THE CONTRACTOR SHALL COORDINATE THE SEQUENCE OF WORK WITH THE OWNER REPRESENTATIVE... THERE SHALL BE NO DEVIATION BY THE GENERAL CONTRACTOR FROM THE CONSTRUCTION DOCUMENTS UNLESS
- APPROVED IN WRITING BY THE ARCHITECT. EACH CONTRACTOR SHALL VERIFY EXISTING CONDITIONS IN THE FIELD PRIOR TO THE INITIATION OF WORK AND SHALL NOTIFY THE ARCHITECT OF ANY DISCREPANCIES OR CONDITIONS INTERFERING WITH THE ABILITY OF THE
- CONTRACTOR TO COMPLETE WORK AS OUTLINED ON THE CONSTRUCTION DRAWINGS. ALL CONTRACTORS ARE REQUIRED TO COORDINATE THEIR WORK WITH OTHER TRADES. LACK OF THIS
- COORDINATION RESULTING IN ADDED COST TO THE CONTRACT WILL BE BORNE BY THE CONTRACTOR. GENERAL CONTRACTOR SHALL BE RESPONSIBLE FOR KEEPING THE EXISTING BUILDING WATER TIGHT DURING
- 10. THE CONTRACTOR WILL VERIFY THAT EXIT EGRESS IS MAINTAINED FOR ALL OCCUPIED AREAS OF THE BUILDING THROUGHOUT ALL PHASES OF CONSTRUCTION.
- PLAN DIMENSIONS ARE GIVEN TO FACE OF STUD OR BLOCK WALL. "CLEAR" DIMENSIONS ARE GIVEN TO THE FACE THE OWNER WILL ASSUME ALL LIABILITY AND SHALL TAKE PERSONAL RESPONSIBILITY FOR ANY DECISIONS THAT THEY MAKE TO CHANGE OR ALTER THE CONSTRUCTION DOCUMENTS WITHOUT THE ARCHITECT'S WRITTEN
- PROTECT ALL EXISTING FINISHES AND MATERIALS TO REMAIN, IN ACCORDANCE WITH ACCEPTABLE TRADE PRACTICES, MANUFACTURER, RECOMMENDATIONS, OR AS DIRECTED BY THE ARCHITECT.
- CUTTING OF EXISTING CONSTRUCTION FOR THE INSTALLATION OF ALL NEW WORK BY ALL TRADES. AND THE SUBSEQUENT PATCHING THEREOF, SHALL BE THE RESPONSIBILITY OF THE GENERAL CONTRACTOR, WHETHER THE WORK IS DONE BY HIS OWN FORCES OR NOT. GRINDING OF MATERIALS FOR REMOVAL SHALL NOT BE PERMITTED. CUTTING SHALL BE TO STRAIGHT LINE. UNWORKMAN-LIKE CUTTING, DAMAGE RESULTING THEREFROM AND UNACCEPTABLE PATCHING SHALL BE REPAIRED AND/OR REPLACED TO AN ACCEPTABLE CONDITION APPROVED BY THE ARCHITECT. A OWNER PROJECT REPRESENTATIVE SHALL BE NOTIFIED PRIOR TO CUTTING OF ANY STRUCTURAL ITEM (I.E. CONCRETE FLOOR, MASONRY, WALL, ETC.) WITHIN THE EXISTING BUILDING. METHOD OF CUTTING SHALL BE APPROVED BY THE OWNER PROJECT REPRESENTATIVE.
- PATCHING MATERIAL SHALL MATCH EXISTING ADJACENT MATERIALS AS CLOSELY AS POSSIBLE IN COLOR,
- PATTERNS, AND/OR TEXTURES. 16. ALL SALVAGE MATERIALS REMOVED SHALL REMAIN THE PROPERTY OF THE OWNER. ALL NON-SALVAGE CONSTRUCTION MATERIALS AND DEBRIS FROM DEMOLITION WORK SHALL BE REMOVED FROM THE SITE AS WORK
- PROGRESSES, UNLESS OTHERWISE NOTED. 17. ISOLATE ALL DISSIMILAR METALS. G SHALL REQUEST APPROVAL BY THE ARCHITECT FOR MATERIALS USED FOR THIS PURPOSE, PRIOR TO INSTALLATION.
- 18. SEALANTS SHALL BE COMPATIBLE WITH ADJACENT SURFACE(S) THAT ARE IN CONTACT. REFER TO SPECIFICATIONS
- FOR APPROVED MANUFACTURERS AND PROCEDURES.
- CAULK JOINTS OF DISSIMILAR EXPOSED TO VIEW MATERIALS AS REQUIRED BY THE ARCHITECT. 20. ALL DOOR HARDWARE TO BE FL. ADA COMPLIANT.
- 21. ALL EXTERIOR WALLS, DOORS AND WINDOWS ARE EXISTING U.N.O.
- ALL FINISHES TO BE PER CLASS INDICATED ON A-004 NO CONSTRUCTION SHALL OCCUR WITHOUT SHOP DRAWING APPROVAL. SHOP DRAWINGS TO BE PROVIDED TO ARCHITECT FOR REVIEW UPON BEING REVIEWED AND SIGNED/DATED BY THE GENERAL CONTRACTOR AND SHALL INCLUDE
- BUT NOT BE LIMITED TO THE FOLLOWING ITEMS: CABINETRY MILLWORK - RUNNING TRIM AND CASING PROFILES
- PAINT/LAMINATE COLOR SAMPLES ACOUSTICAL CEILING AND GRID
- TOILET ACCESSORIES
- KITCHEN EQUIPMENT
- ROOF PENETRATIONS HVAC EQUIPMENT
- PLUMBING EQUIPMENT AND FIXTURES
- ELECTRICAL EQUIPMENT AND FIXTURES
- 24. PRIOR TO COMMENCING WORK, THE CONTRACTOR SHALL SUBMIT (2) COPIES OF MATERIAL SAFETY DATA SHEETS (MSDS) FOR ALL PRODUCTS USED TO PERFORM THE WORK.

VERIFY ACTUAL LOCATIONS AND ELEVATIONS WITH DNR ENGINEER.

ALL WORK SHALL CONFORM TO AND BE PERFORMED IN ACCORDANCE WITH ALL APPLICABLE CODES AND

THE CONTRACTOR SHALL VISIT THE SITE AND INSPECT THE PROJECT AREA AND THOROUGHLY FAMILIARIZE THEMSELVES WITH THE ACTUAL JOB CONDITIONS PRIOR TO BIDDING AND THE START OF WORK. FAILURE TO VISIT THE PROJECT SITE SHALL NOT RELIEVE THE CONTRACTOR FROM PERFORMING THE WORK IN ACCORDANCE TO THE PLANS, SPECIFICATION, SPECIAL PROVISIONS AND CONTRACT.

THE CONTRACTOR SHALL VERIFY, AT THE SITE, ALL DIMENSIONS AND CONDITIONS SHOWN ON THE PLANS AND SHALL NOTIFY THE DNR ENGINEER OF ANY DISCREPANCIES, OMISSIONS, AND/OR CONFLICTS PRIOR TO PROCEEDING WITH THE WORK.

IT SHALL BE THE CONTRACTOR'S RESPONSIBILITY TO PROVIDE WASTE AREAS OR DISPOSAL SITES FOR EXCESS MATERIAL (EXCAVATED MATERIAL OR BROKEN CONCRETE) WHICH IS NOT DESIRABLE TO BE INCORPORATED INTO THE WORK INVOLVED ON THIS PROJECT. NO PAYMENT FOR OVERHAUL WILL BE ALLOWED FOR MATERIAL HAULED TO THESE SITES. NO MATERIAL SHALL BE PLACED WITHIN THE RIGHT-OF-WAY, UNLESS SPECIFICALLY STATED IN THE PLANS OR APPROVED BY THE DNR ENGINEER.

THE CONTRACTOR SHALL NOT DISTURB DESIRABLE GRASS AREAS AND DESIRABLE TREES OUTSIDE THE CONSTRUCTION LIMITS. THE CONTRACTOR WILL NOT BE PERMITTED TO PARK OR SERVICE VEHICLES AND EQUIPMENT OR USE THESE AREAS FOR STORAGE OF MATERIALS. STORAGE, PARKING AND SERVICE AREAS WILL BE SUBJECT TO THE APPROVAL OF THE DNR ENGINEER.

WHERE UTILITIES AND FIXTURES ARE SHOWN AS EXISTING ON THE PLANS OR ENCOUNTERED WITHIN THE CONSTRUCTION AREA, IT SHALL BE THE RESPONSIBILITY OF THE CONTRACTOR TO NOTIFY THE DNR ENGINEER OF THOSE UTILITIES PRIOR TO THE BEGINNING OF ANY CONSTRUCTION. THE CONTRACTOR SHALL BE AFFORDED ACCESS TO THESE FACILITIES FOR NECESSARY MODIFICATION OF SERVICES. UNDERGROUND FACILITIES, STRUCTURES AND UTILITIES HAVE BEEN PLOTTED FROM AVAILABLE SURVEYS AND RECORDS AND THEREFORE THEIR LOCATIONS MUST BE CONSIDERED APPROXIMATE ONLY. IT IS POSSIBLE THERE MAY BE OTHERS, THE EXISTENCE OF WHICH IS PRESENTLY NOT KNOWN OR SHOWN. IT IS THE CONTRACTOR'S RESPONSIBILITY TO DETERMINE THEIR EXISTENCE AND EXACT LOCATION AND TO AVOID DAMAGE THERETO. NO CLAIMS FOR ADDITIONAL COMPENSATION WILL BE ALLOWED TO THE CONTRACTOR FOR ANY INTERFERENCE OR DELAY CAUSED BY SUCH WORK.

THE CONTRACTOR SHALL SHAPE GRADED AREA TO MAINTAIN SURFACE DRAINAGE. ALL ELEVATIONS ARE TO

THE CONTRACTOR IS EXPECTED TO HAVE MATERIALS, EQUIPMENT, AND LABOR AVAILABLE ON A DAILY BASIS TO INSTALL AND MAINTAIN EROSION CONTROL FEATURES ON THE PROJECT. THIS MAY INVOLVE SEEDING, SILT FENCE, ROCK DITCH CHECKS, SILT BASINS OR SILT DIKES.

\*DIVISIONS 20-41 OF THE STANDARD SPECIFICATIONS FOR BRIDGE AND HIGHWAY CONSTRUCTION, CURRENT EDITION WITH GS-15011 SHALL APPLY TO THIS PROJECT.

## PROJECT NARRATIVE

The contractor shall be responsible for providing and installing all items within this narrative, the drawings, and project manual unless specifically noted. This narrative is not meant to be a comprehensive account of all items to be covered by the contract, review all documents. The contractor is responsible for field verifying all dimensions and establishing all quantities that are dictated as "lump sum".

This project, Lake Manawa State Park — Beach Concession Building Remodel, shall commence after the contract is executed and shall be completed no later than the specified completion date.

## Beach Concession Building - Site Work:


The Contractor shall power—wash, with a degreasing detergent, the entire exterior of the building. After thoroughly cleaning the building, the Contractor shall then coat the entire exterior CMU surface with one (1) continuous, thorough coat of CS-1, refer to sheet A-600. The Contractor shall remove all doors shown on the plans, thoroughly clean the doors and the frames, then paint two (2) coats of PNT—1. The Contractor shall remove all gutters, downspouts, fascia boards, and soffits in their entirety and dispose. The Contractor shall then install a new steel soffit, new treated 2x10 fascia with a complete break metal wrap and new gutters and downspouts, the color to be dark bronze on all metal.

The Contractor shall remove all exterior site light poles, remove and dispose of the light heads, then sand—blast the poles and powder coat the poles and bases dark bronze. The Contractor shall then reinstall the light poles and install new LED light heads as called out on sheet A-010. The contractor shall remove the existing overhead coiling door on the NE side of the building. The contractor shall install a new overhead coiling door as called out on sheet A-100.

### Beach Concession Building — Interior Work:


The Contractor shall demolish all toilet partitions, lavatories and countertops, all restroom accessories, seating benches near the entrances, urinal in the Men's restroom, and all light fixtures, lavatory counter braces to remain. The Contractor shall then power—wash, with a degreasing detergent, the entire interior of both restrooms. After thoroughly cleaning the restrooms, the Contractor shall then protect all toilets in place, and paint the entire interior CMU surface with two (2) coats of PNT-2, refer to sheet A-600. The Contractor shall remove all doors shown on the plans, thoroughly clean the doors and frames, then paint two (2) coats of PNT-1. The Contractor shall shall then install a new ADA urinal, as called out. The Contractor shall then install new Bradmar Sentinel 400 overhead—braced toilet partitions. The Contractor shall install a new quartz (QC-1) countertop with lavatory sink bowls, faucets, and accessories as called out. The Contractor shall install all new toilet compartment accessories as called out on the plans. The Contractor shall also replace the countertop at the Concession counter with a new guartz (QC-1) countertop, matching existing outside dimensions. The Contractor shall then clean the interior of the Beach Concession Building of any debris or disturbance that occurred while remodeling the building.

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PROJECT LOCATIC

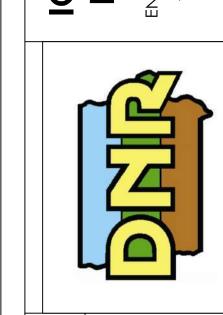Beach Concession Building Remodel for:

A Manawa State

NO. BY REVISION

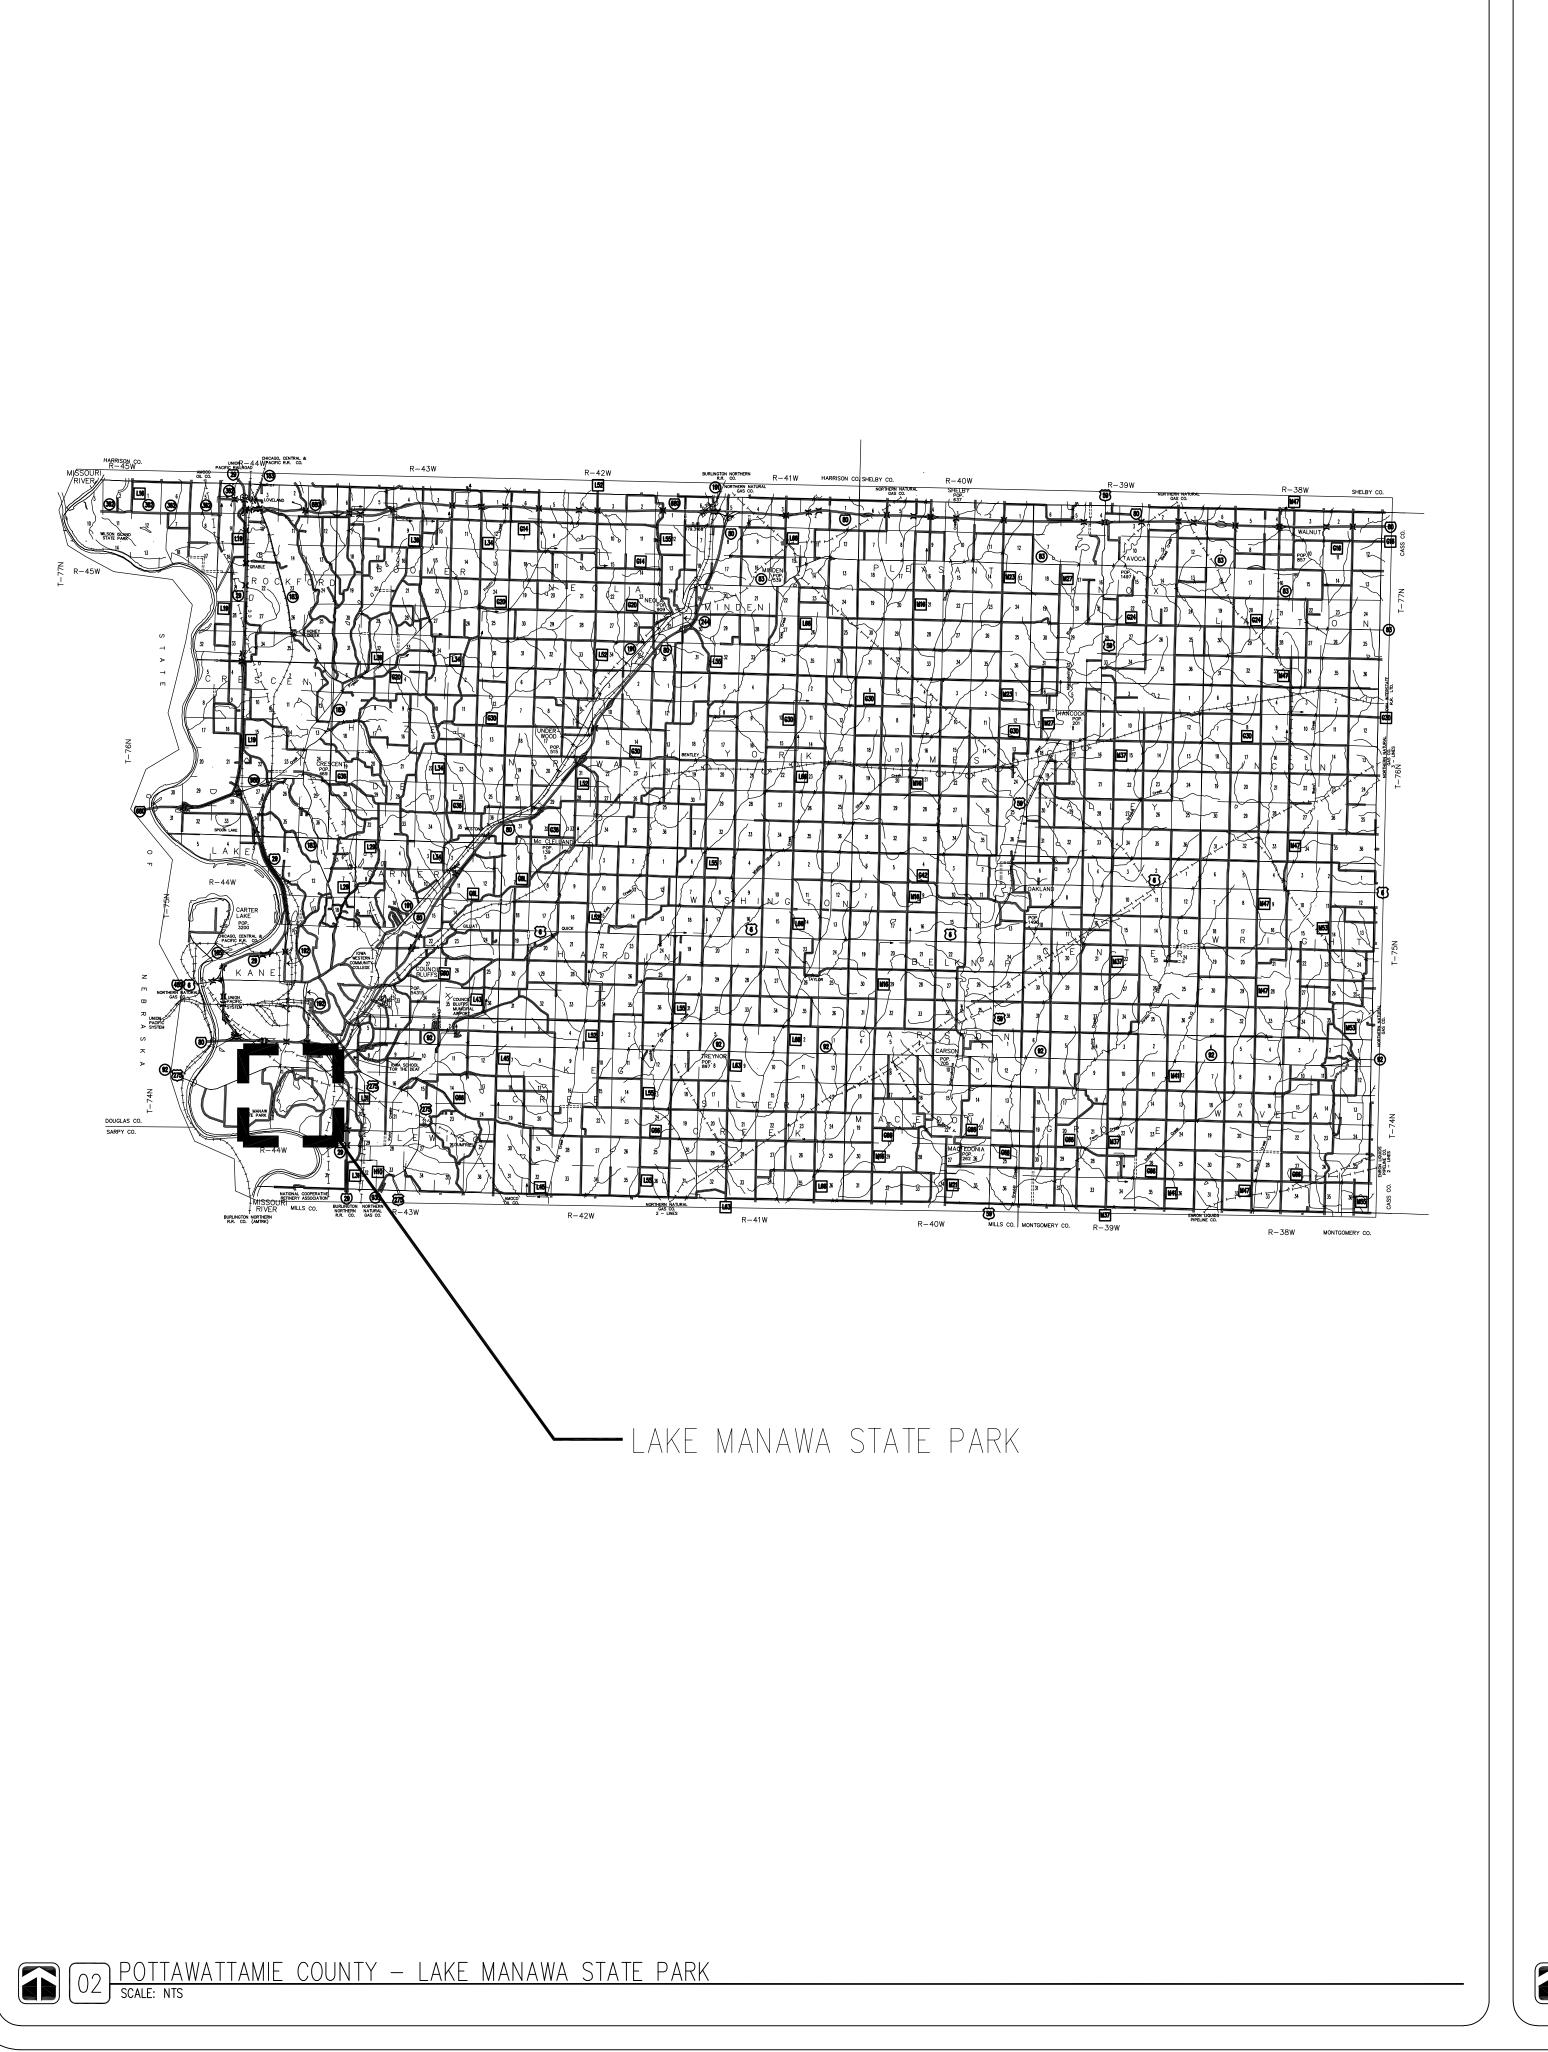DRAWN BY: PROJECT NUMBER: 23-04-78-02

CHK'D BY: DATE: 12-10-00000

12.19.2023 **A-003** 





O2 SITE PLAN — CONCESSION BUILDING SCALE: 1/8" = 1'-0"



KEYNOTES GENERAL NOTES EXISTING FLOORING TO REMAIN. 16. PRESSURE WASH ENTIRE EXTERIOR BUILDING WITH DE-GREASING DETERGENT, CLEAN WITH STIFF NYLON A. FIELD VERIFY ALL DIMENSIONS PRIOR TO CONSTRUCTION. REMOVE EXISTING LIGHT POLE, DEMOLISH LIGHTING HEADS (FIXTURES). SAND BLAST AND THEN BRUSHES. ALLOW TO DRY FOR TWO (2) DAYS, THEN COAT ENTIRE EXTERIOR OF BUILDING WITH CLEAN ENTIRE BUILDING THOROUGHLY, INTERIOR AND EXTERIOR. REFER TO SITE PLAN FOR MORE INFORMATION. MICRO-SEAL WITH ANTI-GRAFFITI CMU BLOCK SEALER, FOLLOWING MANUFACTURER'S APPLICATION POWDER COAT POLES AND BASES DARK BRONZE, REINSTALL AND PREP FOR NEW LIGHT HEAD. ALL ELECTRICAL TO BE NEC 2012 COMPLIANT. DEMOLISH INTERIOR BENCHES. REMOVE TOILET PARTITIONS, PROTECT FOR FUTURE USE. ALL PLUMBING TO BE IPC 2012 COMPLIANT. 17. 26 GAUGE, VENTED, STEEL SOFFIT PANEL, DARK BRONZE TO MATCH FASCIA AND GUTTERS. 5. TOILETS TO REMAIN, PROTECT IN PLACE. CONTRACTOR TO PROVIDE "J" AND "T" TRIM WHERE NECESSARY SO RAW EDGES ARE NOT EXPOSED. DEMOLISH URINAL FIXTURE. 18. SAND-BLAST AND POWDER-COAT LIGHT POLE AND BASE COVER, DARK BRONZE. REINSTALL POLE DEMOLISH ALL COUNTER TOPS, SINKS AND TRIM, PREP FOR NEW MATERIAL INSTALL. ANGLED AND BASE WITH ONE (1) NEW HUBBLE VSP-48L-110-4K7-4-UNV-AD-DB LIGHT HEAD EACH, FOR A SUPPORTS TO REMAIN. TOTAL OF FOUR (4) LIGHT HEADS. 8. DEMOLISH HAND DRYER, PREP J-BOX AND ELECTRICAL FOR NEW HAND DRYER. 9. REMOVE EXISTING LIGHTING, PREP J-BOX AND ELECTRICAL FOR NEW LIGHTING FIXTURE. 10. REMOVE EXISTING RESTROOM ACCESSORIES. 11. DEMOLISH EXISTING COILING DOOR, PREP BLOCK FOR INSTALL OF NEW DOOR. 12. REMOVE DOORS AS SPECIFIED ON SHEET A-600. CLEAN DOORS AND FRAMES, PREP FOR PAINT AND 13. DEMOLISH ALL GUTTERS, DOWNSPOUTS, WOOD SOFFIT MATERIAL, AND FASCIA. PREP EAVE EDGE FOR NEW MATERIAL. 14. 6" GUTTER AND DOWNSPOUT WITH SHUR-FLO GUTTER GUARDS, CONTINUOUS OR APPROVED EQUAL, DARK BRONZE. 15. PRESSURE TREATED 2X10 FASCIA, MATCH EXISTING DIMENSIONS, WRAP FASCIA IN BREAK METAL, DARK



 $\Box$ 

SITE

BUILDING


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23-04-78-02

12.19.2023

A-010



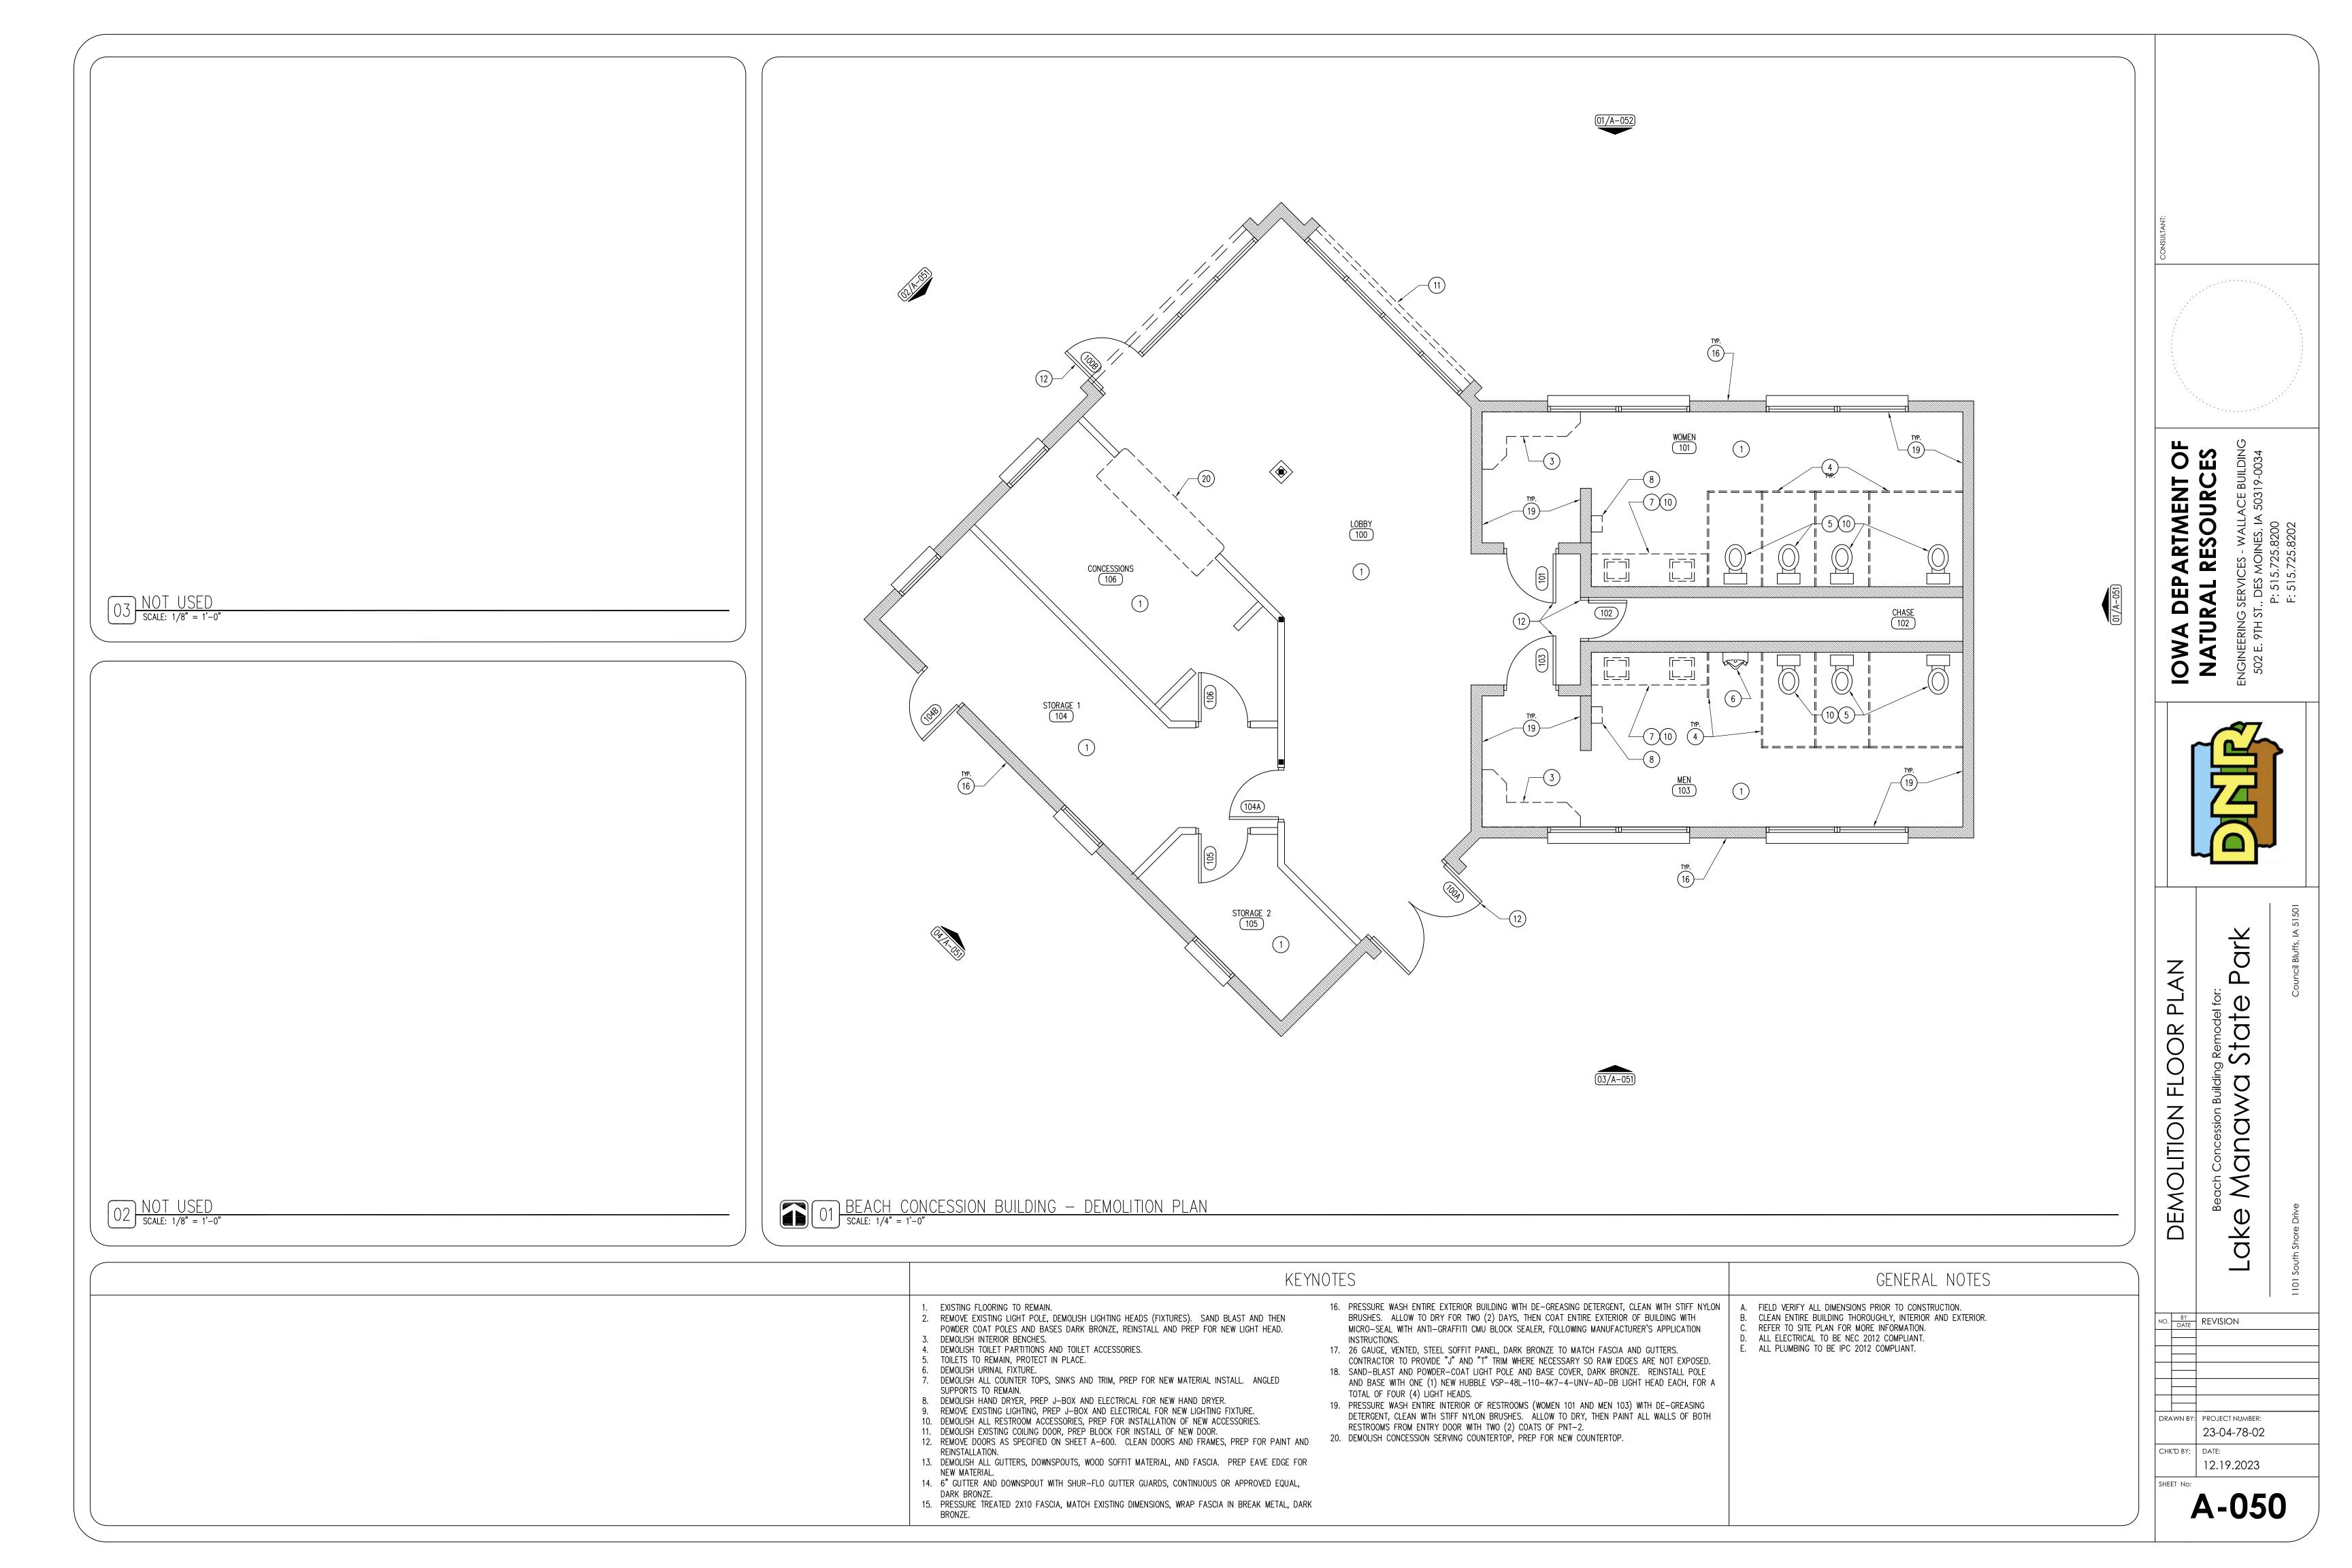

04 BEACH CONCESSION BUILDING - SOUTH WEST FACADE SCALE: NTS



03 BEACH CONCESSION BUILDING — SOUTH EAST FACADE SCALE: NTS



02 BEACH CONCESSION BUILDING — NORTH WEST FACADE scale: NTS



01 BEACH CONCESSION BUILDING — EAST FACADE scale: NTS

KEYNOTES GENERAL NOTES

- EXISTING FLOORING TO REMAIN. REMOVE EXISTING LIGHT POLE, DEMOLISH LIGHTING HEADS (FIXTURES). SAND BLAST AND THEN
- POWDER COAT POLES AND BASES DARK BRONZE, REINSTALL AND PREP FOR NEW LIGHT HEAD.

  DEMOLISH INTERIOR BENCHES.
- DEMOLISH TOILET PARTITIONS AND TOILET ACCESSORIES.
- TOILETS TO REMAIN, PROTECT IN PLACE.

NEW MATERIAL.

- DEMOLISH URINAL FIXTURE. DEMOLISH ALL COUNTER TOPS, SINKS AND TRIM, PREP FOR NEW MATERIAL INSTALL. ANGLED
- SUPPORTS TO REMAIN.
- 8. DEMOLISH HAND DRYER, PREP J-BOX AND ELECTRICAL FOR NEW HAND DRYER.
- . REMOVE EXISTING LIGHTING, PREP J-BOX AND ELECTRICAL FOR NEW LIGHTING FIXTURE. 10. DEMOLISH CONCESSION SERVING COUNTERTOP, PREP FOR NEW COUNTERTOP.
- 11. DEMOLISH EXISTING COILING DOOR, PREP BLOCK FOR INSTALL OF NEW DOOR. 12. REMOVE DOORS AS SPECIFIED ON SHEET A-600. CLEAN DOORS AND FRAMES, PREP FOR PAINT AND
- 13. DEMOLISH ALL GUTTERS, DOWNSPOUTS, WOOD SOFFIT MATERIAL, AND FASCIA. PREP EAVE EDGE FOR
- 14. 6" GUTTER AND DOWNSPOUT WITH SHUR-FLO GUTTER GUARDS, CONTINUOUS OR APPROVED EQUAL, 15. PRESSURE TREATED 2X10 FASCIA, MATCH EXISTING DIMENSIONS, WRAP FASCIA IN BREAK METAL, DARK
- 16. PRESSURE WASH ENTIRE EXTERIOR BUILDING WITH DE-GREASING DETERGENT, CLEAN WITH STIFF NYLON BRUSHES. ALLOW TO DRY FOR TWO (2) DAYS, THEN COAT ENTIRE EXTERIOR OF BUILDING WITH MICRO-SEAL WITH ANTI-GRAFFITI CMU BLOCK SEALER, FOLLOWING MANUFACTURER'S APPLICATION
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- TOTAL OF FOUR (4) LIGHT HEADS. 19. PRESSURE WASH ENTIRE INTERIOR OF RESTROOMS (WOMEN 101 AND MEN 103) WITH DE-GREASING DETERGENT, CLEAN WITH STIFF NYLON BRUSHES. ALLOW TO DRY, THEN PAINT ALL WALLS OF BOTH RESTROOMS FROM ENTRY DOOR WITH TWO (2) COATS OF PNT-2.
- FIELD VERIFY ALL DIMENSIONS PRIOR TO CONSTRUCTION. CLEAN ENTIRE BUILDING THOROUGHLY, INTERIOR AND EXTERIOR. REFER TO SITE PLAN FOR MORE INFORMATION. ALL ELECTRICAL TO BE NEC 2012 COMPLIANT.

ALL PLUMBING TO BE IPC 2012 COMPLIANT.

23-04-78-02

A-051


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DRAWN BY: PROJECT NUMBER:



04 BEACH CONCESSION BUILDING — SOFFIT / FASCIA DETAIL scale: NTS



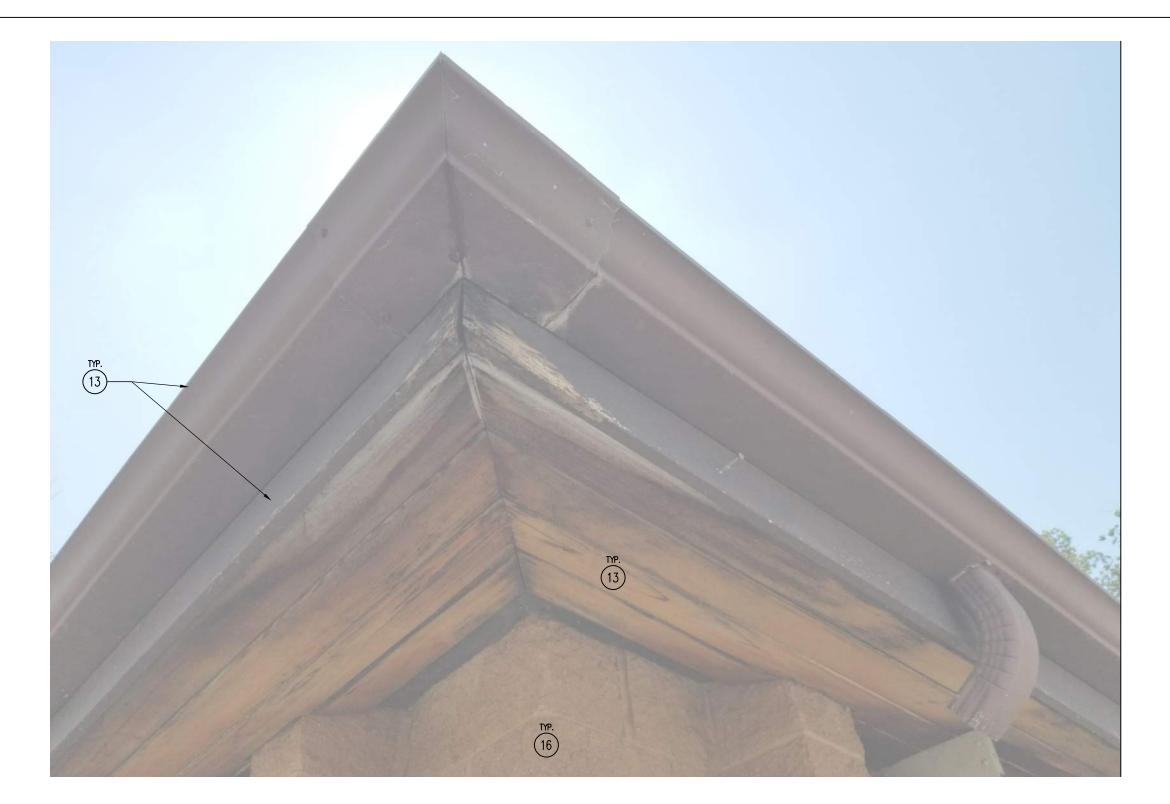

02 BEACH CONCESSION BUILDING — COILING OVERHEAD DOOR DETAIL scale: NTS



01 BEACH CONCESSION BUILDING — NORTH WEST FACADE SCALE: NTS

### KEYNOTES GENERAL NOTES 16. PRESSURE WASH ENTIRE EXTERIOR BUILDING WITH DE-GREASING DETERGENT, CLEAN WITH STIFF NYLON EXISTING FLOORING TO REMAIN. FIELD VERIFY ALL DIMENSIONS PRIOR TO CONSTRUCTION. CLEAN ENTIRE BUILDING THOROUGHLY, INTERIOR AND EXTERIOR. BRUSHES. ALLOW TO DRY FOR TWO (2) DAYS, THEN COAT ENTIRE EXTERIOR OF BUILDING WITH REMOVE EXISTING LIGHT POLE, DEMOLISH LIGHTING HEADS (FIXTURES). SAND BLAST AND THEN MICRO-SEAL WITH ANTI-GRAFFITI CMU BLOCK SEALER, FOLLOWING MANUFACTURER'S APPLICATION POWDER COAT POLES AND BASES DARK BRONZE, REINSTALL AND PREP FOR NEW LIGHT HEAD. DEMOLISH INTERIOR BENCHES. REFER TO SITE PLAN FOR MORE INFORMATION.

- DEMOLISH TOILET PARTITIONS AND TOILET ACCESSORIES.
- TOILETS TO REMAIN, PROTECT IN PLACE. DEMOLISH URINAL FIXTURE.
- DEMOLISH ALL COUNTER TOPS, SINKS AND TRIM, PREP FOR NEW MATERIAL INSTALL. ANGLED
- SUPPORTS TO REMAIN.
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- 15. PRESSURE TREATED 2X10 FASCIA, MATCH EXISTING DIMENSIONS, WRAP FASCIA IN BREAK METAL, DARK
- 17. 26 GAUGE, VENTED, STEEL SOFFIT PANEL, DARK BRONZE TO MATCH FASCIA AND GUTTERS.
- CONTRACTOR TO PROVIDE "J" AND "T" TRIM WHERE NECESSARY SO RAW EDGES ARE NOT EXPOSED. 18. SAND-BLAST AND POWDER-COAT LIGHT POLE AND BASE COVER, DARK BRONZE. REINSTALL POLE

AND BASE WITH ONE (1) NEW HUBBLE VSP-48L-110-4K7-4-UNV-AD-DB LIGHT HEAD EACH, FOR A

- TOTAL OF FOUR (4) LIGHT HEADS. 19. PRESSURE WASH ENTIRE INTERIOR OF RESTROOMS (WOMEN 101 AND MEN 103) WITH DE-GREASING DETERGENT, CLEAN WITH STIFF NYLON BRUSHES. ALLOW TO DRY, THEN PAINT ALL WALLS OF BOTH RESTROOMS FROM ENTRY DOOR WITH TWO (2) COATS OF PNT-2.

ALL ELECTRICAL TO BE NEC 2012 COMPLIANT. ALL PLUMBING TO BE IPC 2012 COMPLIANT.

NO. DATE REVISION

DRAWN BY: PROJECT NUMBER: 23-04-78-02 12.19.2023

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**PHOTOS** 

EXTERIOR


A-052



04 BEACH CONCESSION BUILDING — MEN 103 — URINAL SCALE: NTS



03 BEACH CONCESSION BUILDING — ADA TOILET AREA scale: NTS

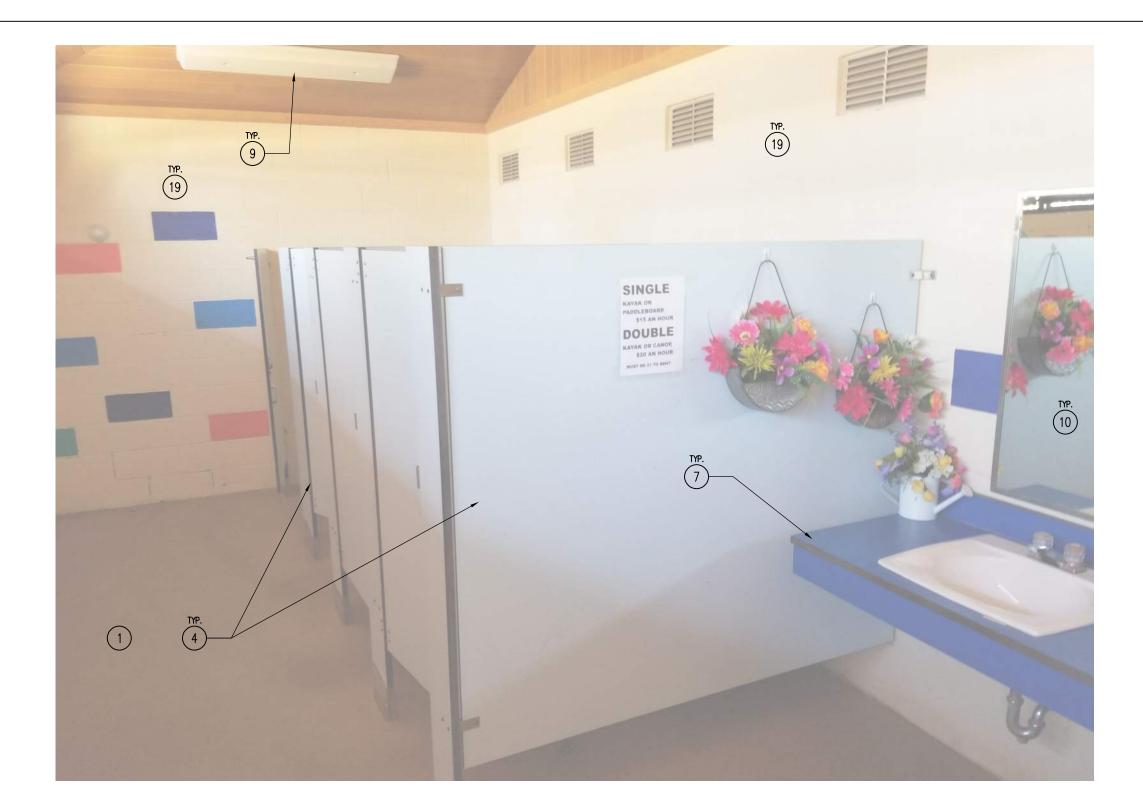

02 BEACH CONCESSION BUILDING — WOMEN 101 scale: NTS



01 BEACH CONCESSION BUILDING — LAVATORY COUNTER scale: NTS

## KEYNOTES

- EXISTING FLOORING TO REMAIN. REMOVE EXISTING LIGHT POLE, DEMOLISH LIGHTING HEADS (FIXTURES). SAND BLAST AND THEN
- POWDER COAT POLES AND BASES DARK BRONZE, REINSTALL AND PREP FOR NEW LIGHT HEAD.
- DEMOLISH INTERIOR BENCHES. DEMOLISH TOILET PARTITIONS AND TOILET ACCESSORIES.
- TOILETS TO REMAIN, PROTECT IN PLACE. DEMOLISH URINAL FIXTURE.
- DEMOLISH ALL COUNTER TOPS, SINKS AND TRIM, PREP FOR NEW MATERIAL INSTALL. ANGLED
- SUPPORTS TO REMAIN.
- 8. DEMOLISH HAND DRYER, PREP J-BOX AND ELECTRICAL FOR NEW HAND DRYER. 9. REMOVE EXISTING LIGHTING, PREP J-BOX AND ELECTRICAL FOR NEW LIGHTING FIXTURE.
- 10. DEMOLISH ALL RESTROOM ACCESSORIES, PREP FOR INSTALLATION OF NEW ACCESSORIES. 11. DEMOLISH EXISTING COILING DOOR, PREP BLOCK FOR INSTALL OF NEW DOOR.
- 12. REMOVE DOORS AS SPECIFIED ON SHEET A-600. CLEAN DOORS AND FRAMES, PREP FOR PAINT AND
- 13. DEMOLISH ALL GUTTERS, DOWNSPOUTS, WOOD SOFFIT MATERIAL, AND FASCIA. PREP EAVE EDGE FOR NEW MATERIAL.
- 15. PRESSURE TREATED 2X10 FASCIA, MATCH EXISTING DIMENSIONS, WRAP FASCIA IN BREAK METAL, DARK

14. 6" GUTTER AND DOWNSPOUT WITH SHUR-FLO GUTTER GUARDS, CONTINUOUS OR APPROVED EQUAL,

- 16. PRESSURE WASH ENTIRE EXTERIOR BUILDING WITH DE-GREASING DETERGENT, CLEAN WITH STIFF NYLON BRUSHES. ALLOW TO DRY FOR TWO (2) DAYS, THEN COAT ENTIRE EXTERIOR OF BUILDING WITH MICRO-SEAL WITH ANTI-GRAFFITI CMU BLOCK SEALER, FOLLOWING MANUFACTURER'S APPLICATION


  - 17. 26 GAUGE, VENTED, STEEL SOFFIT PANEL, DARK BRONZE TO MATCH FASCIA AND GUTTERS.
  - CONTRACTOR TO PROVIDE "J" AND "T" TRIM WHERE NECESSARY SO RAW EDGES ARE NOT EXPOSED.
  - 18. SAND-BLAST AND POWDER-COAT LIGHT POLE AND BASE COVER, DARK BRONZE. REINSTALL POLE AND BASE WITH ONE (1) NEW HUBBLE VSP-48L-110-4K7-4-UNV-AD-DB LIGHT HEAD EACH, FOR A TOTAL OF FOUR (4) LIGHT HEADS.
  - 19. PRESSURE WASH ENTIRE INTERIOR OF RESTROOMS (WOMEN 101 AND MEN 103) WITH DE-GREASING DETERGENT, CLEAN WITH STIFF NYLON BRUSHES. ALLOW TO DRY, THEN PAINT ALL WALLS OF BOTH
  - RESTROOMS FROM ENTRY DOOR WITH TWO (2) COATS OF PNT-2. 20. DEMOLISH CONCESSION SERVING COUNTERTOP, PREP FOR NEW COUNTERTOP.


## GENERAL NOTES


- FIELD VERIFY ALL DIMENSIONS PRIOR TO CONSTRUCTION.
- CLEAN ENTIRE BUILDING THOROUGHLY, INTERIOR AND EXTERIOR.
- ALL PLUMBING TO BE IPC 2012 COMPLIANT.
- REFER TO SITE PLAN FOR MORE INFORMATION. ALL ELECTRICAL TO BE NEC 2012 COMPLIANT.

DRAWN BY: PROJECT NUMBER: 23-04-78-02

NO. DATE REVISION

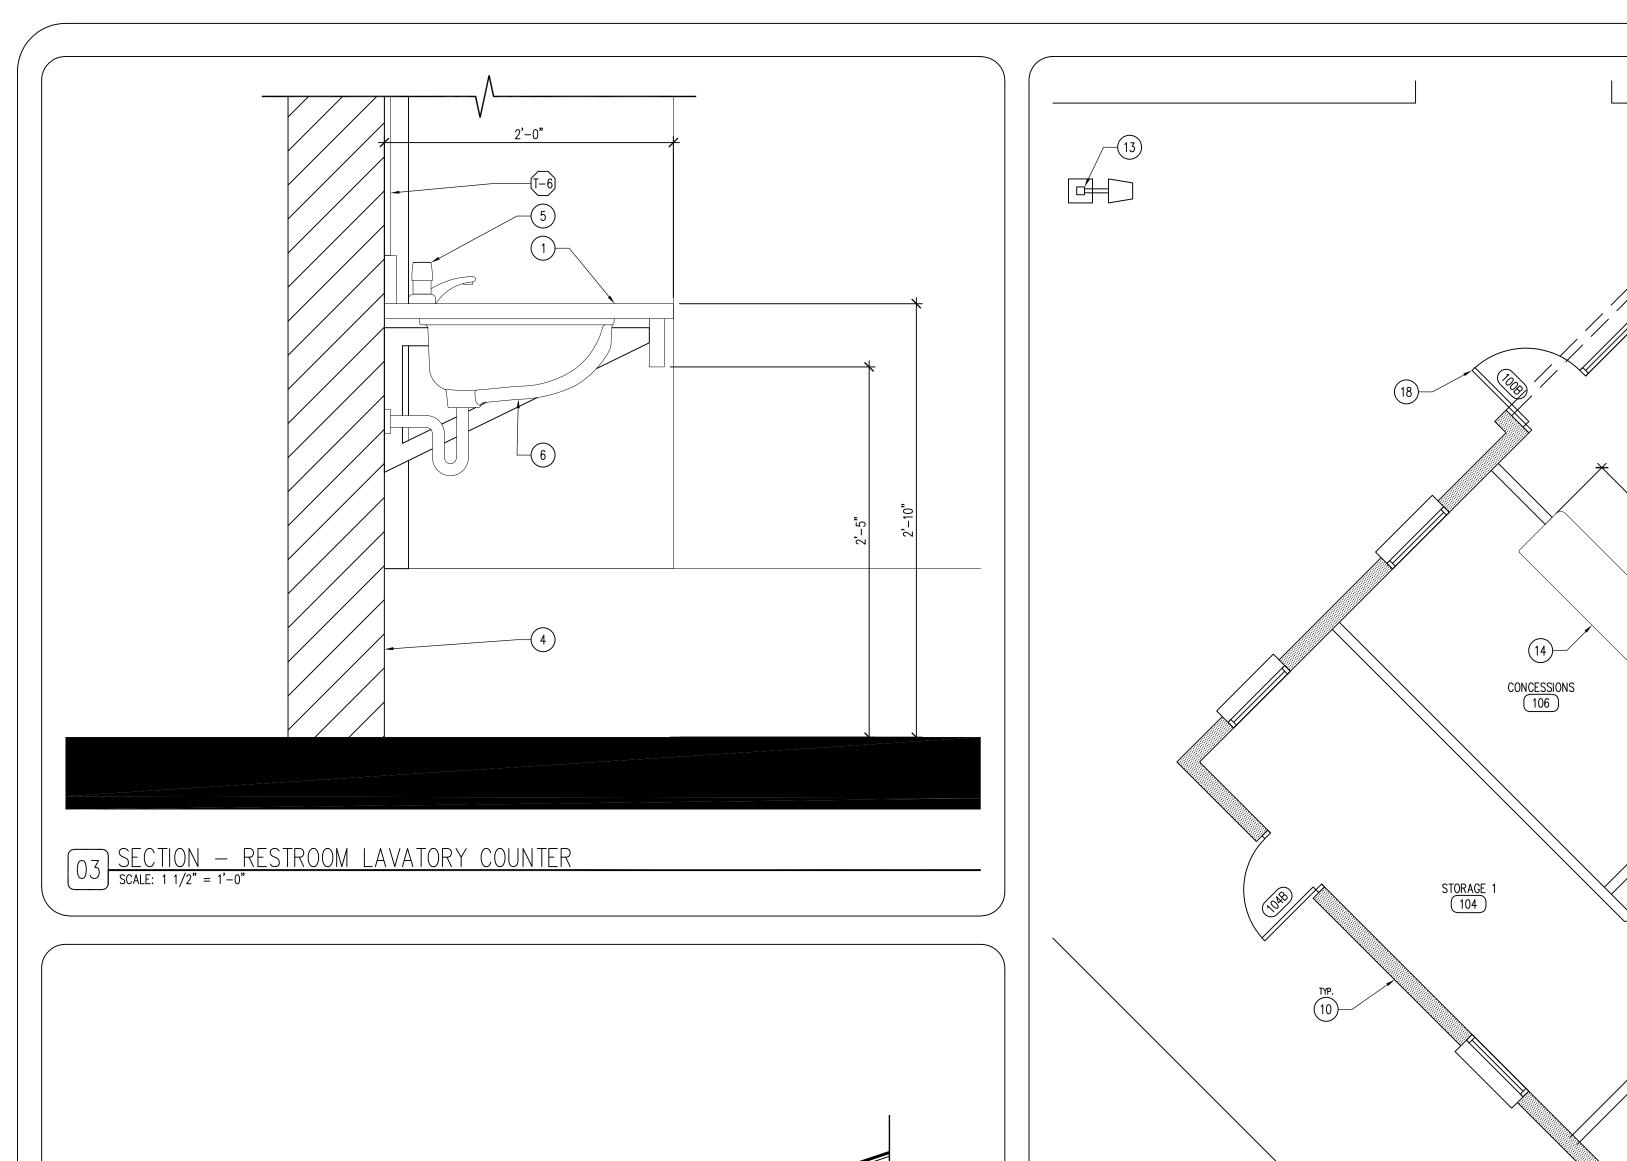


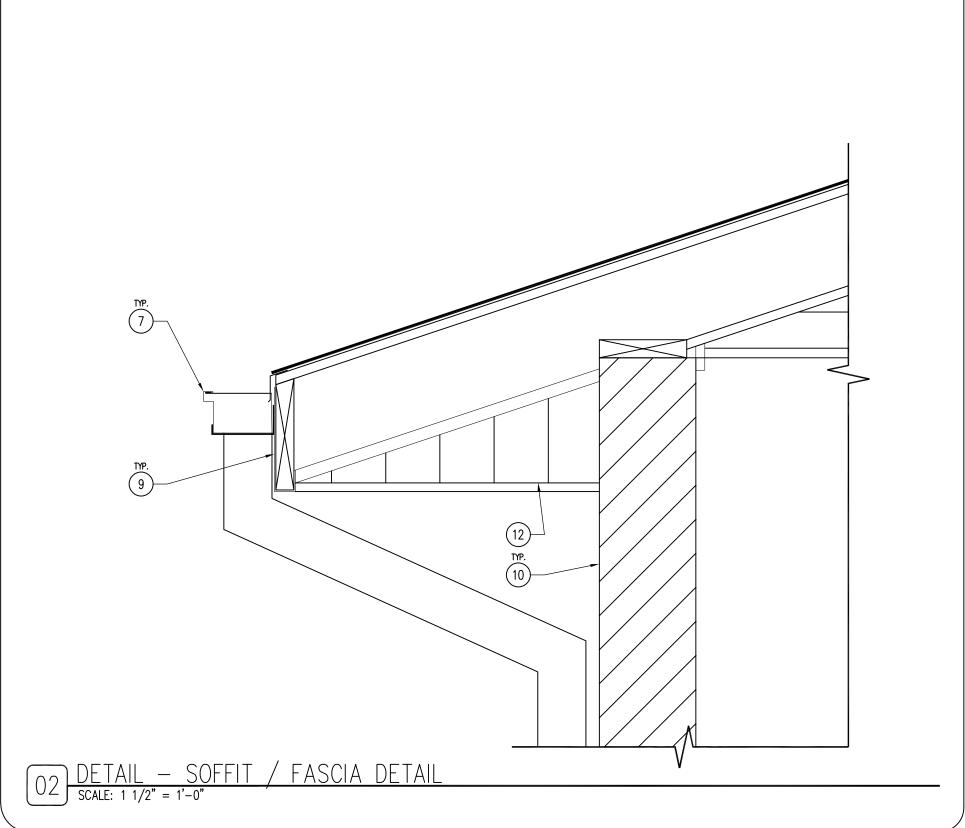


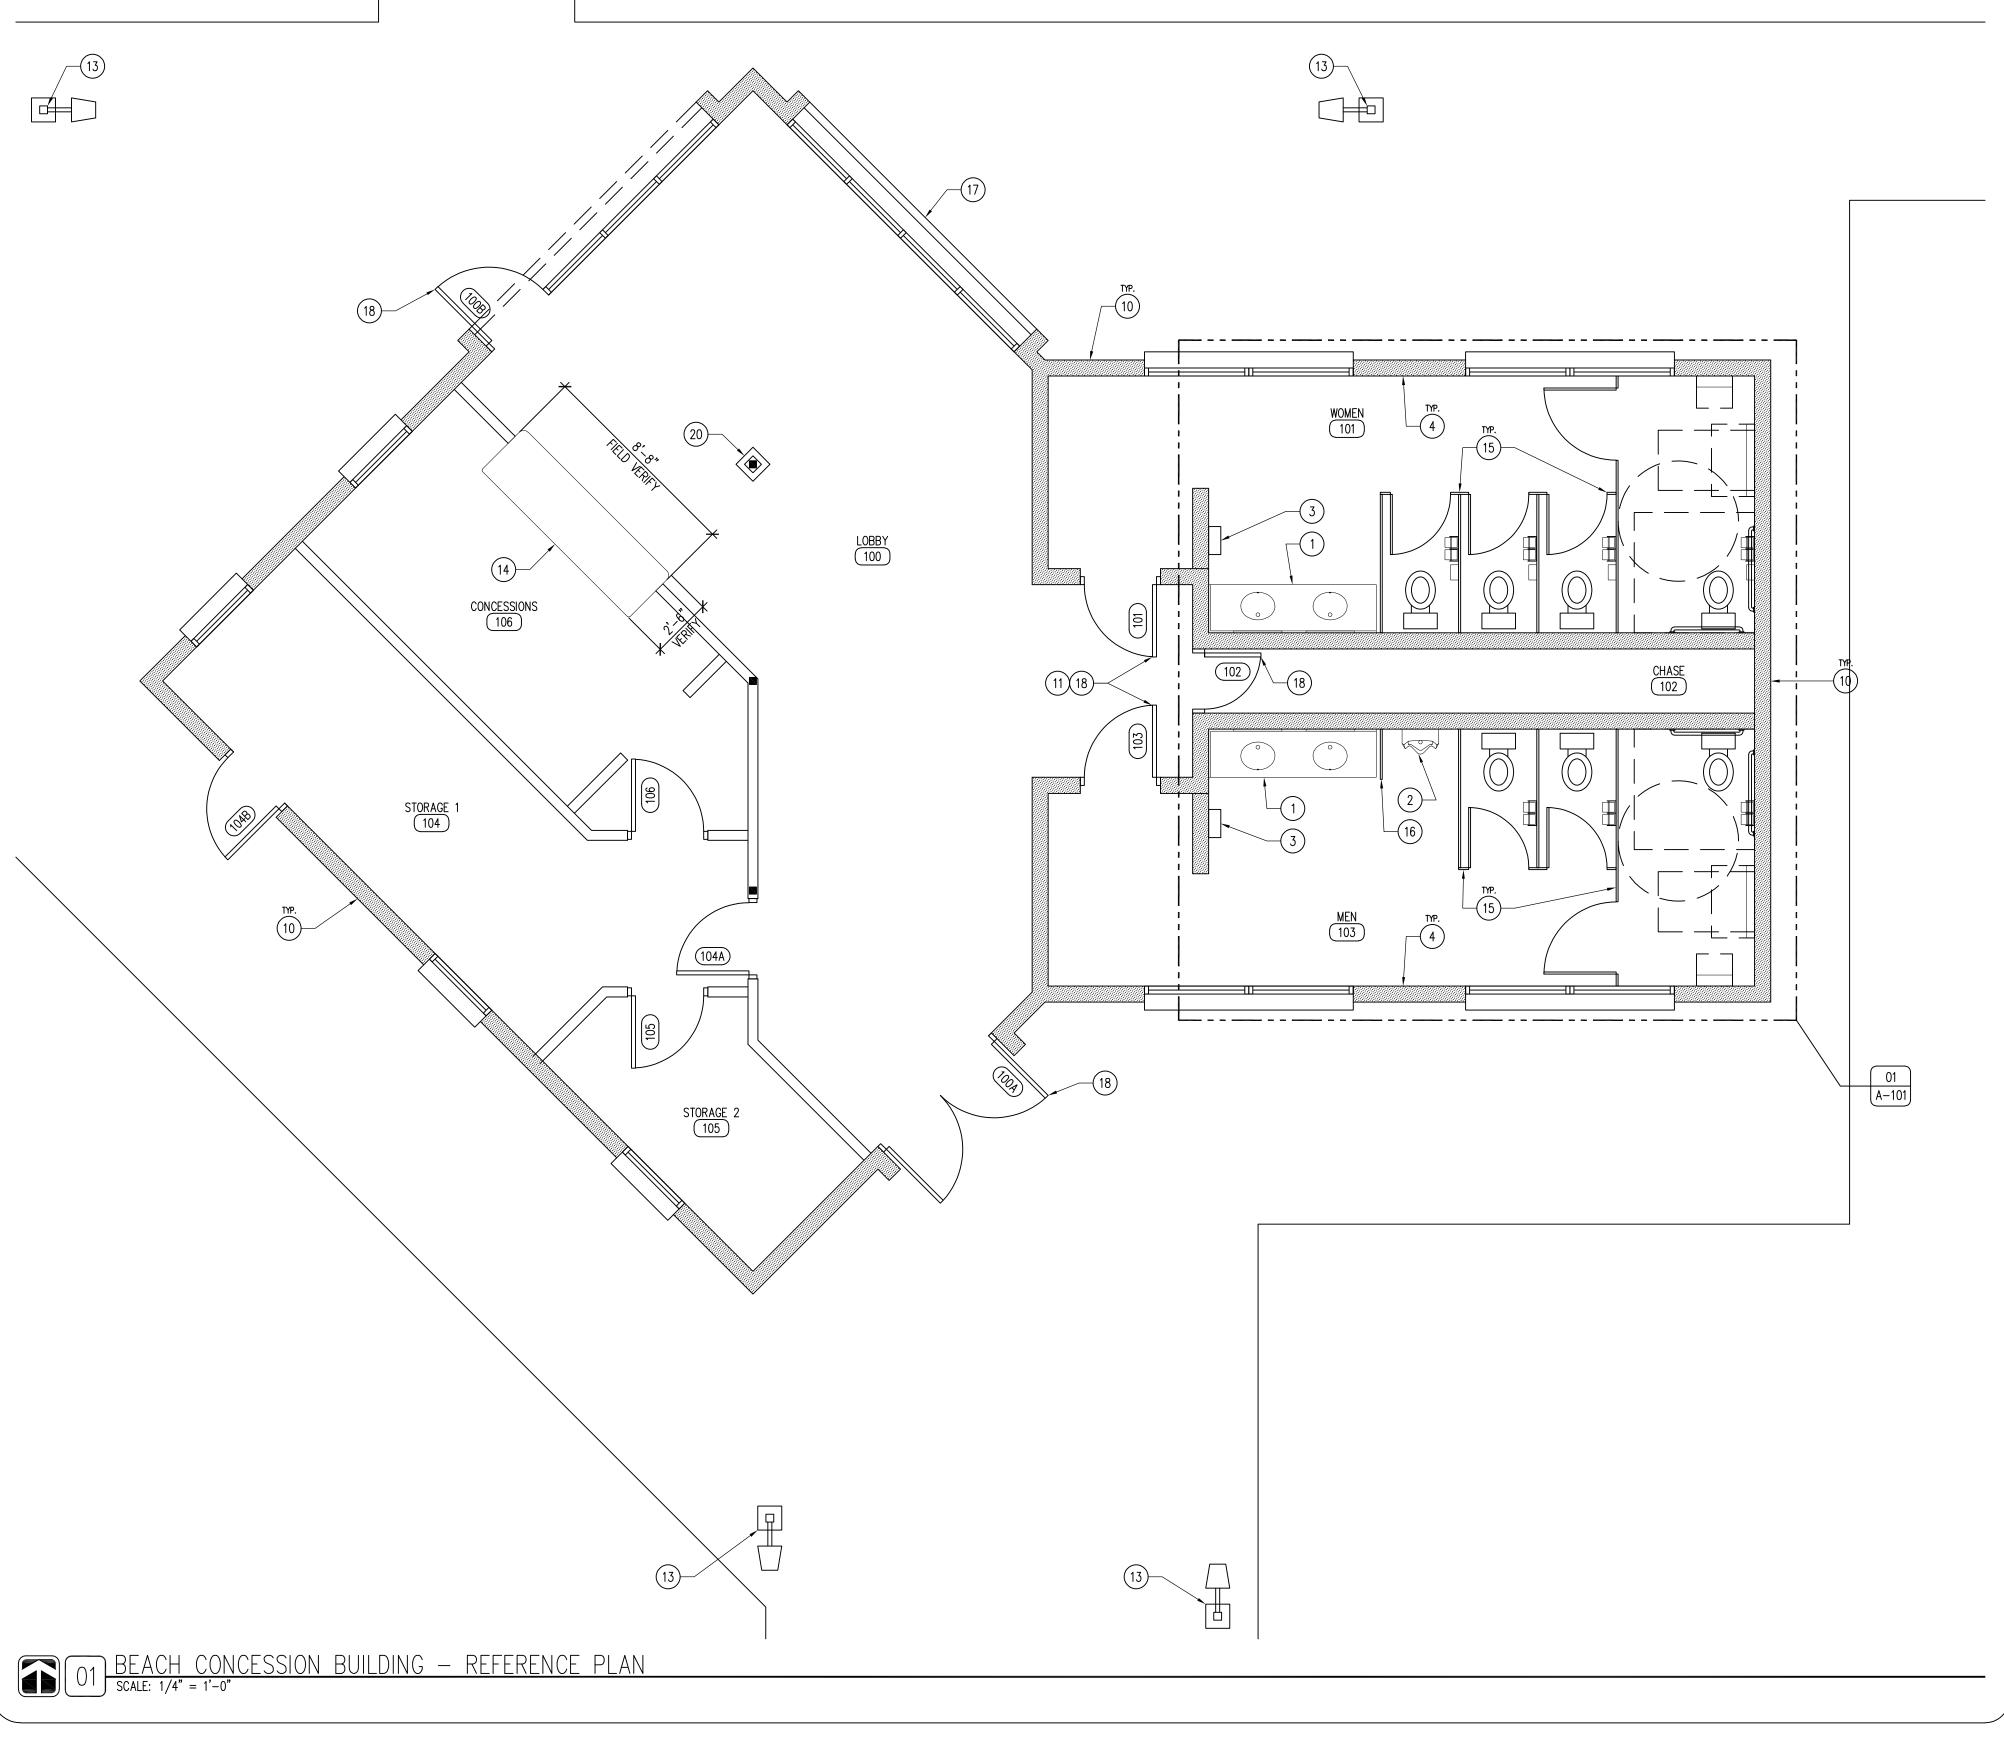



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KEYNOTES TOILET ACCESSORY SCHEDULE GENERAL NOTES FIELD VERIFY ALL DIMENSIONS PRIOR TO CONSTRUCTION. ALL MODEL NUMBERS BASED ON BOBRICK WASHROOM EQUIPMENT UNLESS OTHERWISE NOTED. 10. PRESSURE WASH ENTIRE EXTERIOR BUILDING WITH DE-GREASING DETERGENT, CLEAN WITH STIFF NYLON 17. OVERHEAD COILING DOOR, 22GA GALVANIZED STEEL, 1 ½" X ½" FLAT STEEL SLAT. DOOR TO BE QUARTZ COUNTERTOP (QC-1) OR APPROVED EQUAL, OVER 3 PLYWOOD WITH 4" VALENCE AND 4" BRUSHES. ALLOW TO DRY FOR TWO (2) DAYS, THEN COAT ENTIRE EXTERIOR OF BUILDING WITH T-1) SURFACE-MOUNTED MULTI-ROLL TOILET PAPER DISPENSER B-274 BACKSPLASH, REUSE EXISTING ANGLE SUPPORTS, OR APPROVED EQUAL. REFER TO DETAIL 03/A-100. LOCKABLE FROM THE EXTERIOR. HOOD TO BE 24GA STEEL, MOUNT DOOR TO INTERIOR OF EXISTING REFER TO SITE PLAN FOR MORE INFORMATION. MICRO-SEAL WITH ANTI-GRAFFITI CMU BLOCK SEALER, FOLLOWING MANUFACTURER'S APPLICATION 2. ADA URINAL - AMERICAN STANDARD 0.5 GPF MANUAL ADA URINAL (6561.017), MOUNT SO RIM OF CMU JAMB, MANUAL CRANK OPERATION, COLOR TO BE DARK BRONZE, FIELD VERIFY DIMENSIONS.

- T-2 CONCEALED MOUNTING WITH SNAP FLANGE GRAB BARS  $B-6806 \times 42$
- CONCEALED MOUNTING WITH SNAP FLANGE GRAB BARS
  B-6806 x 36

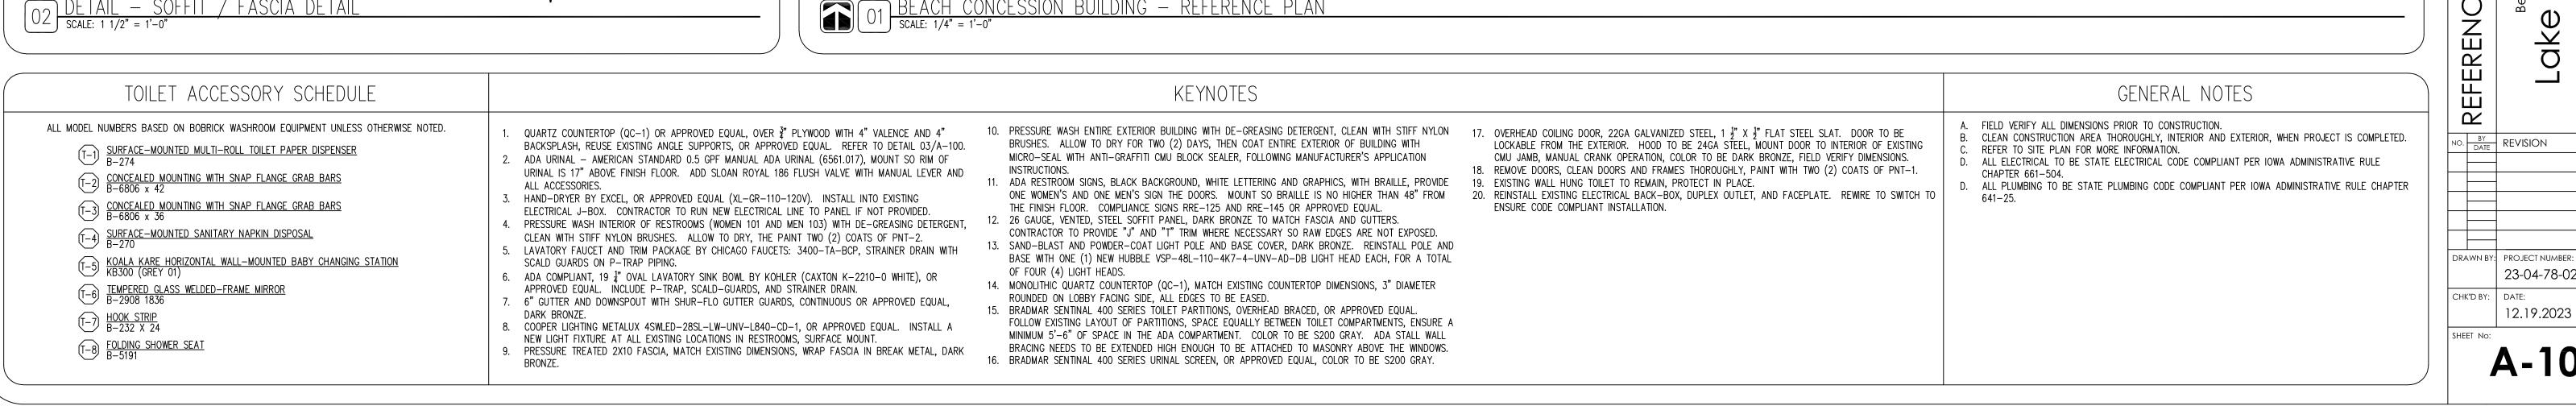- (T-5) KOALA KARE HORIZONTAL WALL-MOUNTED BABY CHANGING STATION KB300 (GREY 01)

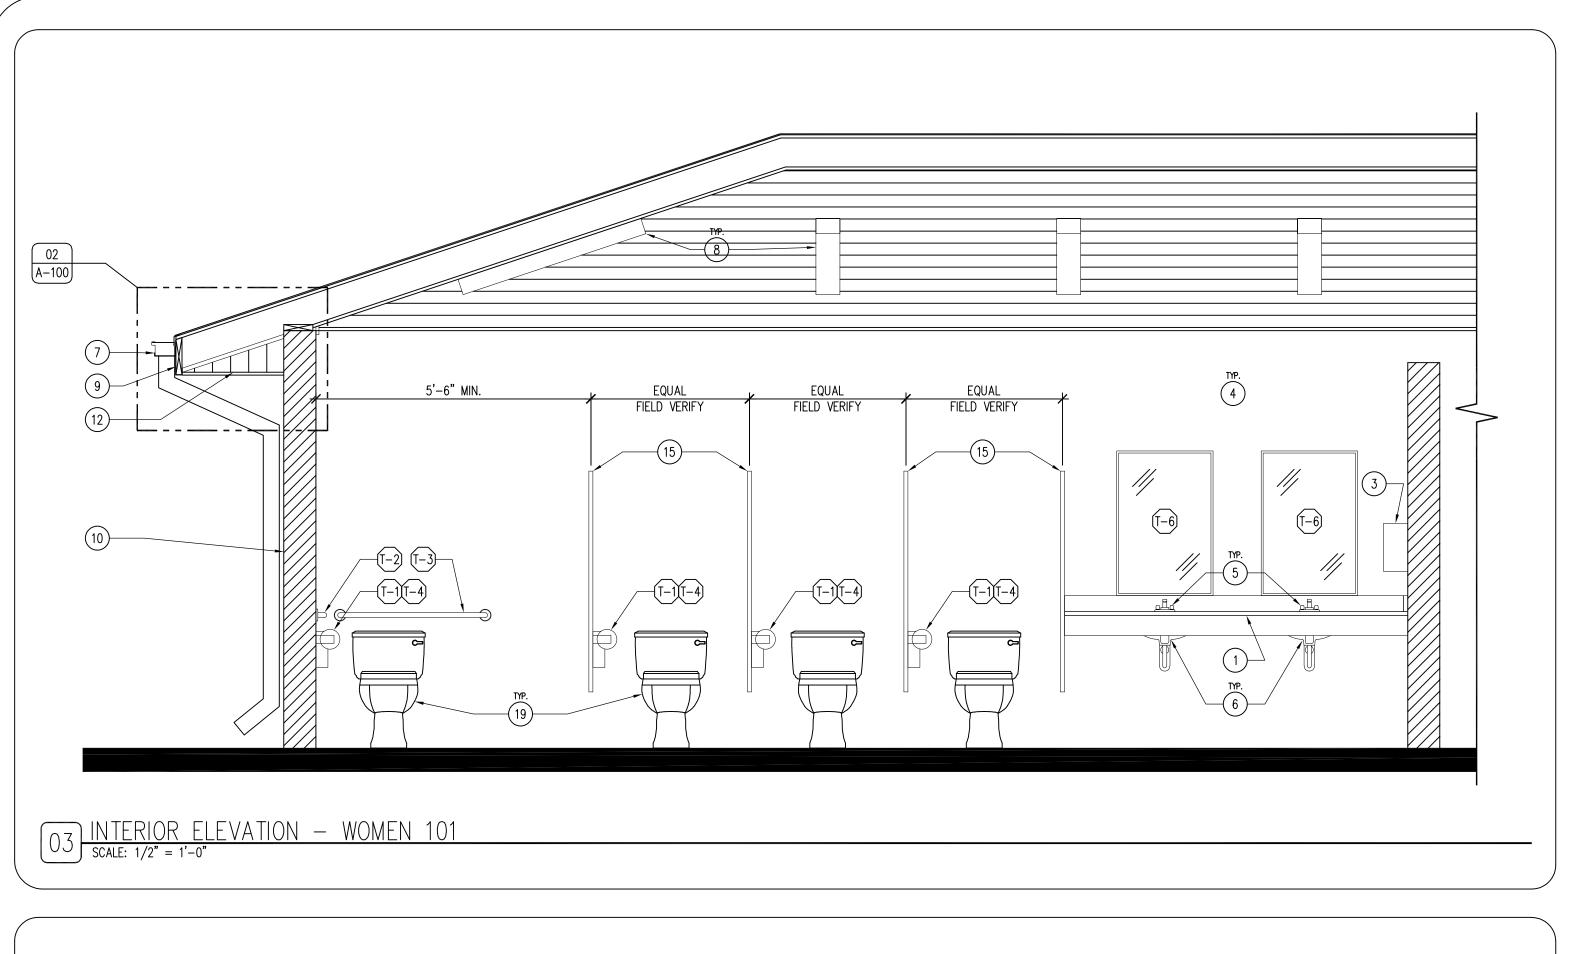- T-8 FOLDING SHOWER SEAT B-5191

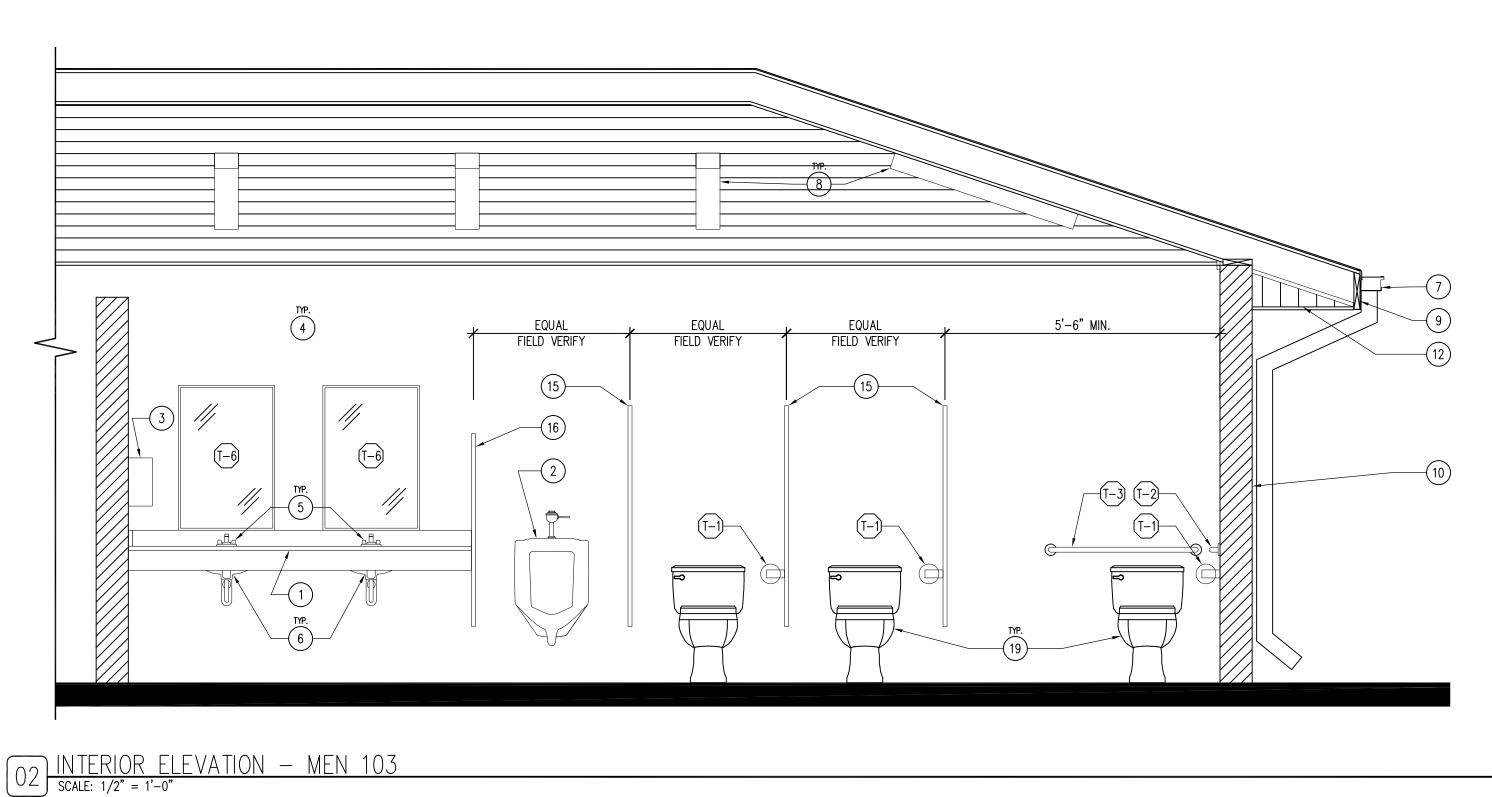- URINAL IS 17" ABOVE FINISH FLOOR. ADD SLOAN ROYAL 186 FLUSH VALVE WITH MANUAL LEVER AND ALL ACCESSORIES.
- HAND-DRYER BY EXCEL, OR APPROVED EQUAL (XL-GR-110-120V). INSTALL INTO EXISTING ELECTRICAL J-BOX. CONTRACTOR TO RUN NEW ELECTRICAL LINE TO PANEL IF NOT PROVIDED.
- PRESSURE WASH INTERIOR OF RESTROOMS (WOMEN 101 AND MEN 103) WITH DE-GREASING DETERGENT, CLEAN WITH STIFF NYLON BRUSHES. ALLOW TO DRY, THE PAINT TWO (2) COATS OF PNT-2.
- 5. LAVATORY FAUCET AND TRIM PACKAGE BY CHICAGO FAUCETS: 3400-TA-BCP, STRAINER DRAIN WITH SCALD GUARDS ON P-TRAP PIPING. 6. ADA COMPLIANT, 19  $\frac{1}{4}$ " OVAL LAVATORY SINK BOWL BY KOHLER (CAXTON K-2210-0 WHITE), OR
- APPROVED EQUAL. INCLUDE P-TRAP, SCALD-GUARDS, AND STRAINER DRAIN. 7. 6" GUTTER AND DOWNSPOUT WITH SHUR-FLO GUTTER GUARDS, CONTINUOUS OR APPROVED EQUAL,
- 8. COOPER LIGHTING METALUX 4SWLED-28SL-LW-UNV-L840-CD-1, OR APPROVED EQUAL. INSTALL A NEW LIGHT FIXTURE AT ALL EXISTING LOCATIONS IN RESTROOMS, SURFACE MOUNT. PRESSURE TREATED 2X10 FASCIA, MATCH EXISTING DIMENSIONS, WRAP FASCIA IN BREAK METAL, DARK BRONZE.
- INSTRUCTIONS.
- 11. ADA RESTROOM SIGNS, BLACK BACKGROUND, WHITE LETTERING AND GRAPHICS, WITH BRAILLE, PROVIDE THE FINISH FLOOR. COMPLIANCE SIGNS RRE-125 AND RRE-145 OR APPROVED EQUAL. 12. 26 GAUGE, VENTED, STEEL SOFFIT PANEL, DARK BRONZE TO MATCH FASCIA AND GUTTERS.
- CONTRACTOR TO PROVIDE "J" AND "T" TRIM WHERE NECESSARY SO RAW EDGES ARE NOT EXPOSED. 13. SAND-BLAST AND POWDER-COAT LIGHT POLE AND BASE COVER, DARK BRONZE. REINSTALL POLE AND BASE WITH ONE (1) NEW HUBBLE VSP-48L-110-4K7-4-UNV-AD-DB LIGHT HEAD EACH, FOR A TOTAL OF FOUR (4) LIGHT HEADS.
- 14. MONOLITHIC QUARTZ COUNTERTOP (QC-1), MATCH EXISTING COUNTERTOP DIMENSIONS, 3" DIAMETER ROUNDED ON LOBBY FACING SIDE, ALL EDGES TO BE EASED.

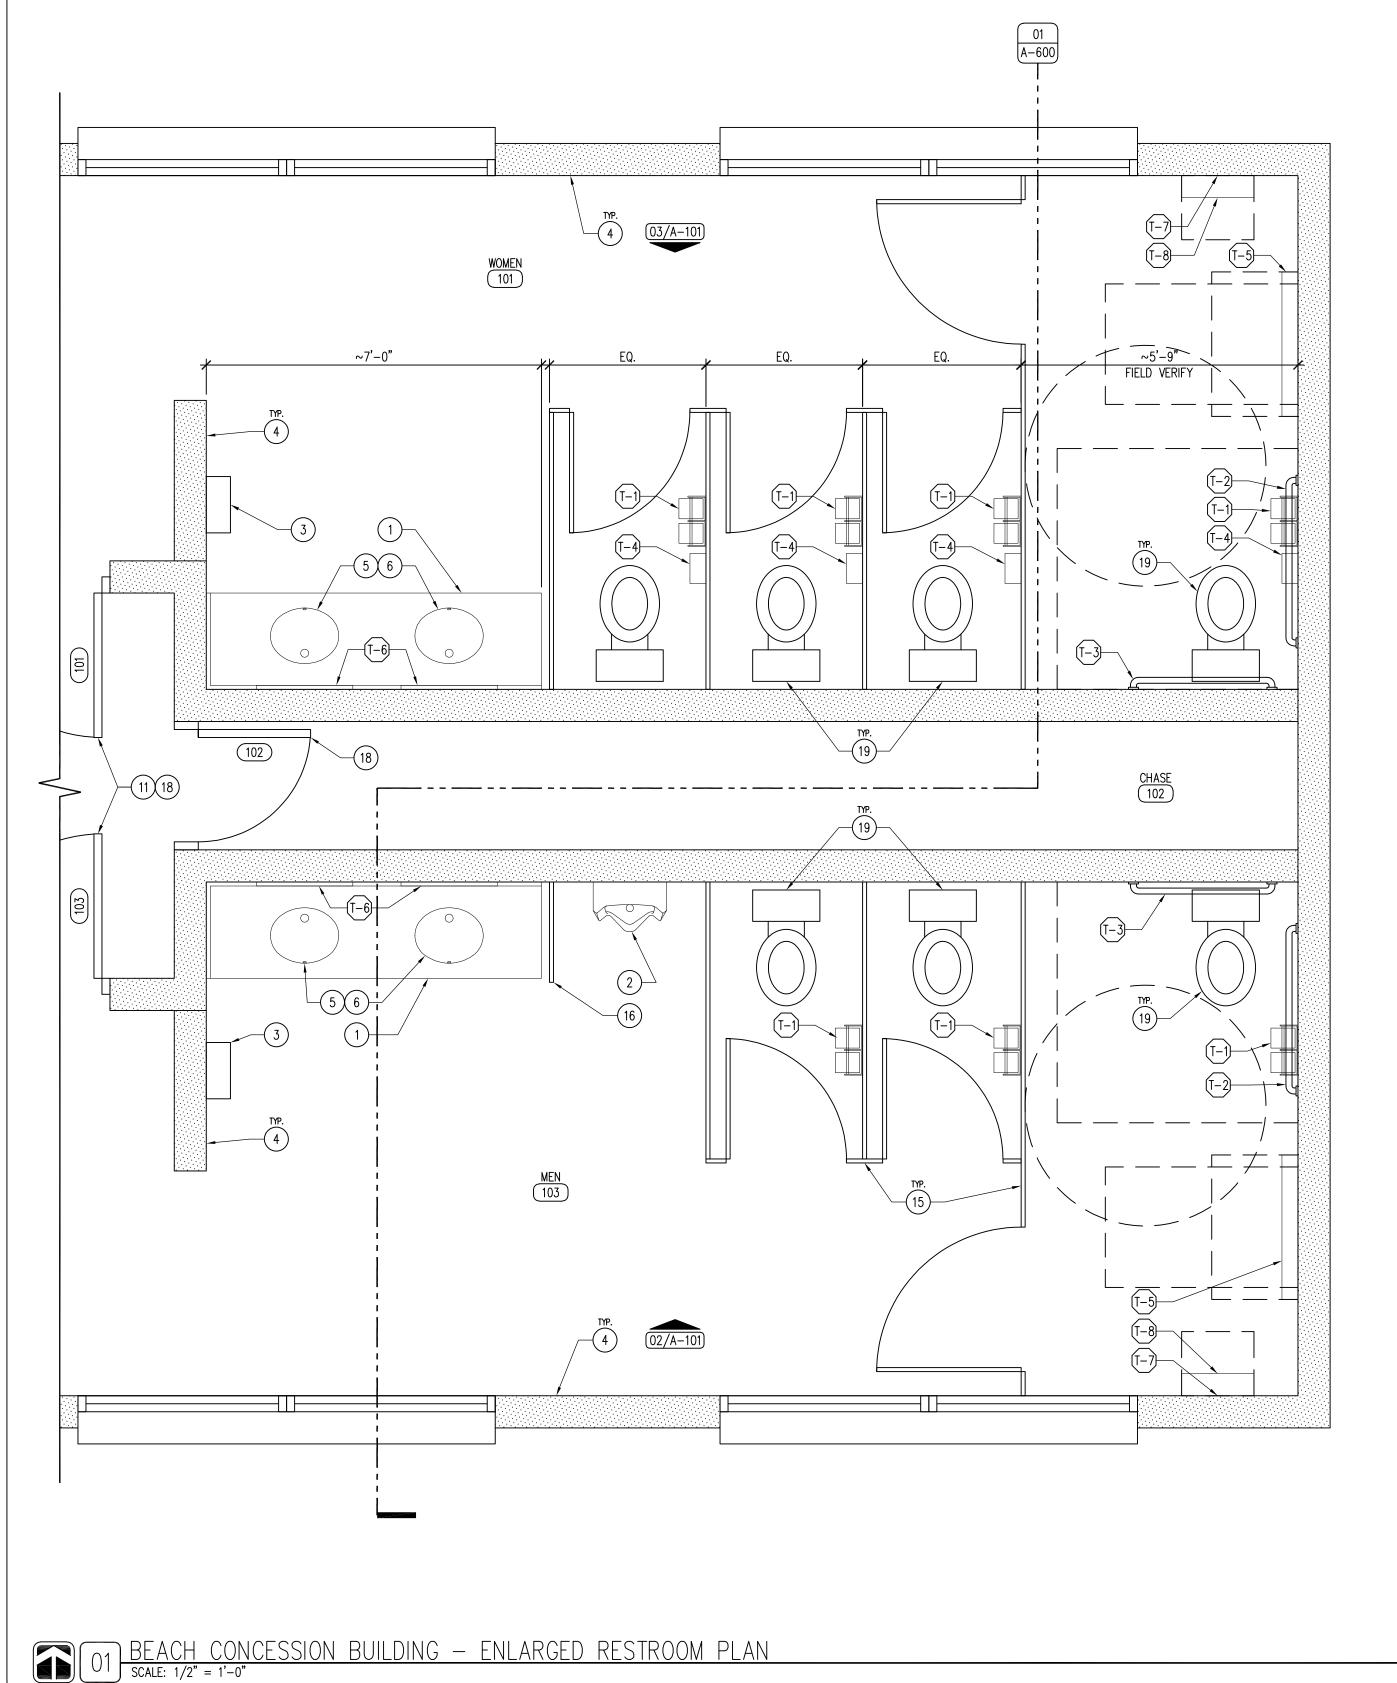15. BRADMAR SENTINAL 400 SERIES TOILET PARTITIONS, OVERHEAD BRACED, OR APPROVED EQUAL.

- FOLLOW EXISTING LAYOUT OF PARTITIONS, SPACE EQUALLY BETWEEN TOILET COMPARTMENTS, ENSURE A MINIMUM 5'-6" OF SPACE IN THE ADA COMPARTMENT. COLOR TO BE S200 GRAY. ADA STALL WALL BRACING NEEDS TO BE EXTENDED HIGH ENOUGH TO BE ATTACHED TO MASONRY ABOVE THE WINDOWS. 16. BRADMAR SENTINAL 400 SERIES URINAL SCREEN, OR APPROVED EQUAL, COLOR TO BE S200 GRAY.
- 18. REMOVE DOORS, CLEAN DOORS AND FRAMES THOROUGHLY, PAINT WITH TWO (2) COATS OF PNT-1.
- 19. EXISTING WALL HUNG TOILET TO REMAIN, PROTECT IN PLACE. ONE WOMEN'S AND ONE MEN'S SIGN THE DOORS. MOUNT SO BRAILLE IS NO HIGHER THAN 48" FROM 20. REINSTALL EXISTING ELECTRICAL BACK-BOX, DUPLEX OUTLET, AND FACEPLATE. REWIRE TO SWITCH TO ENSURE CODE COMPLIANT INSTALLATION.
- CLEAN CONSTRUCTION AREA THOROUGHLY, INTERIOR AND EXTERIOR, WHEN PROJECT IS COMPLETED.
- ALL ELECTRICAL TO BE STATE ELECTRICAL CODE COMPLIANT PER IOWA ADMINISTRATIVE RULE CHAPTER 661-504.
- ALL PLUMBING TO BE STATE PLUMBING CODE COMPLIANT PER IOWA ADMINISTRATIVE RULE CHAPTER 641-25.

DRAWN BY: PROJECT NUMBER:

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23-04-78-02

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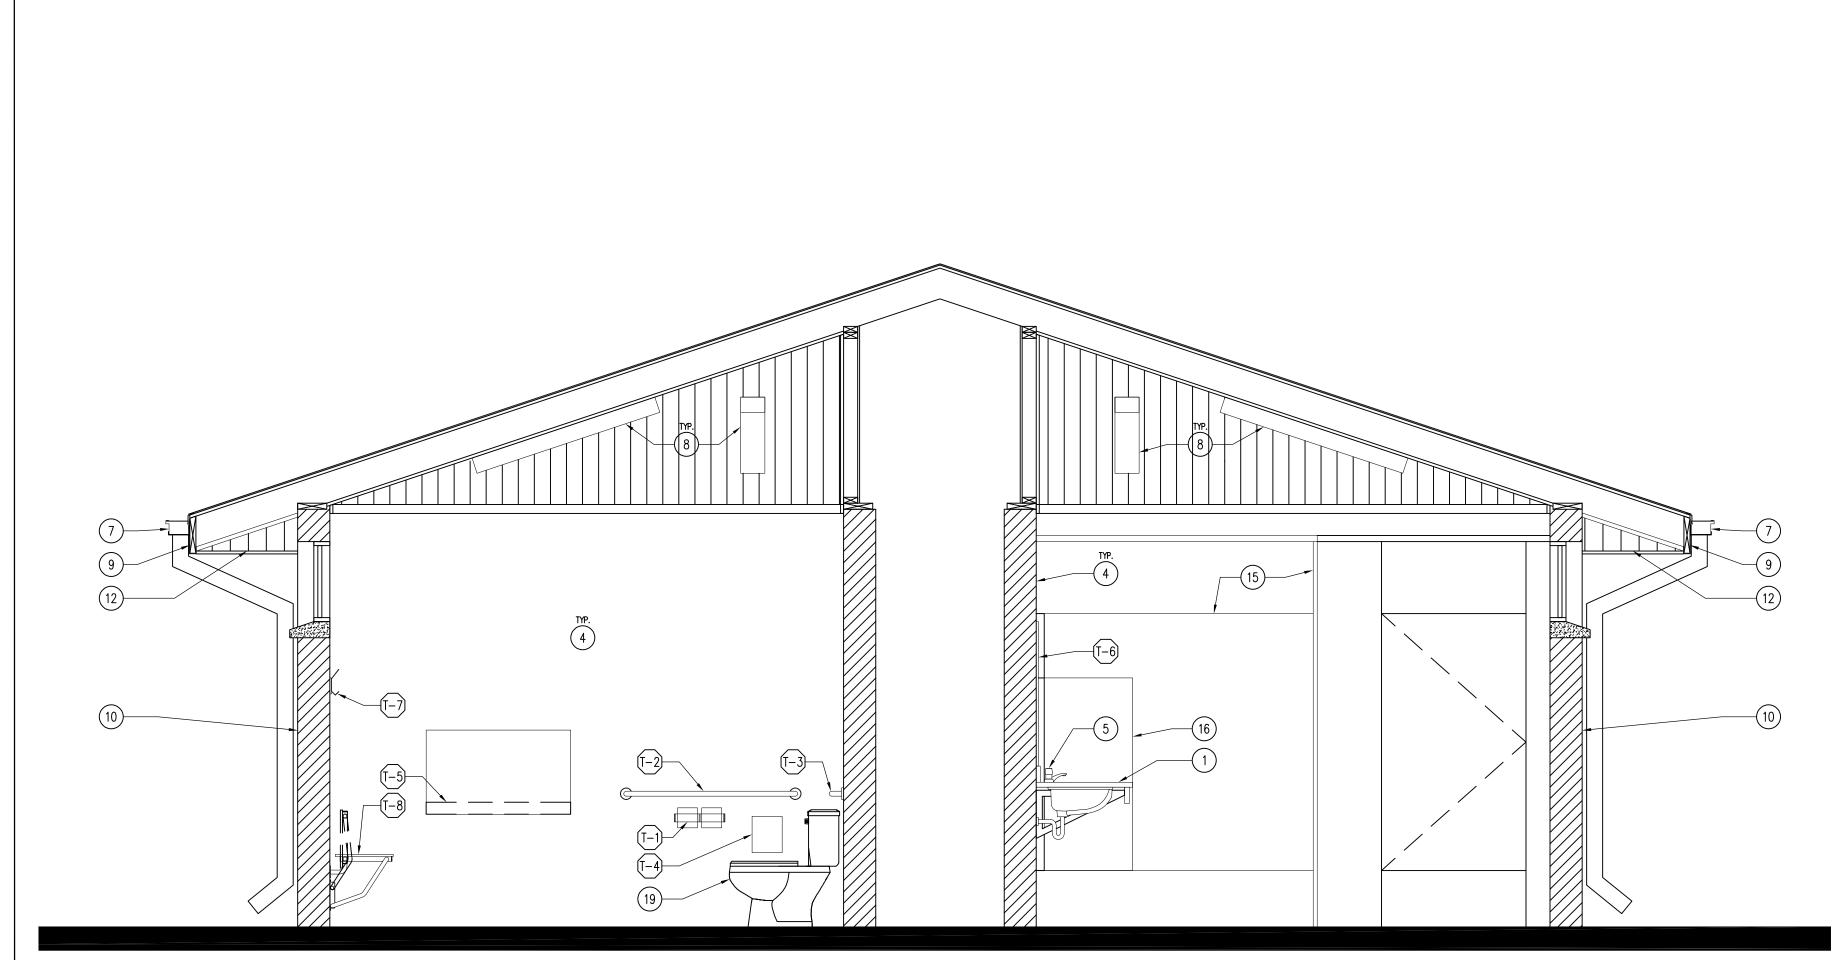
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NO. BY REVISION

	DOOR SCHEDULE															
DOOR							FRAME									
DOOR	l	DIMENSION		TVDE	OL ACC	FINICIA		DETAILS		TVDE	EMICH	FIRE RATING		HARDWARE		COMMENTS
NUMBER	WIDTH	HEIGHT	THICK.	TYPE	GLASS	FINISH	HEAD	JAMB	THRESHOLD	TYPE	FINISH	LABEL	SET #	KEYSIDE ROOM NUMBER		
100A	6'-0"	7'-0"	_	EXISTING	-	PNT-1	-	-	-	EXISTING	PNT-1		ı	-	REMOVE, CLEAN, AND PAINT TWO (2) COATS	
100B	3'-0"	7'-0"	_	EXISTING	_	EXISTING	-	-	-	EXISTING	EXISTING		-	-	CLEAN	
101	3'-0"	7'-0"	_	EXISTING	_	PNT-1	-	-	_	EXISTING	PNT-1		-	-	REMOVE, CLEAN, AND PAINT TWO (2) COATS	
102	3'-0"	7'-0"	_	EXISTING	_	PNT-1	-	-	_	EXISTING	PNT-1		-	-	REMOVE, CLEAN, AND PAINT TWO (2) COATS	
103	3'-0"	7'-0"	-	EXISTING	-	PNT-1	-	-	_	EXISTING	PNT-1		-	_	REMOVE, CLEAN, AND PAINT TWO (2) COATS	
104A	3'-0"	7'-0"	_	EXISTING	_	PNT-1	-	-	_	EXISTING	PNT-1		-	-	REMOVE, CLEAN, AND PAINT TWO (2) COATS	
104B	3'-0"	7'-0"	_	EXISTING	_	EXISTING	-	-	-	EXISTING	EXISTING		-	-	CLEAN	
105	3'-0"	7'-0"	_	EXISTING	_	EXISTING	-	-	-	EXISTING	EXISTING		-	-	CLEAN	
106	3'-0"	7'-0"	-	EXISTING	-	EXISTING	-	-	_	EXISTING	EXISTING		-	-	CLEAN	

	ROOM SCHEDULE									
1	ROOM #	ROOM NAME	FLOORING	BASE	NORTH WALL FINISH	EAST WALL FINISH	SOUTH WALL FINISH	WEST WALL FINISH	CEILING	NOTES / COMMENTS
	100	LOBBY	-	_	-	_	_	-	-	-
	101	WOMEN	_	-	PNT-2	PNT-2	PNT-2	PNT-2	_	CLEAN AND PAINT TWO (2) COATS
	102	CHASE	_	-	-	-	-	_	_	-
	103	MEN	-	_	PNT-2	PNT-2	PNT-2	PNT-2	_	CLEAN AND PAINT TWO (2) COATS
	104	STORAGE 1	-	_	_	_	_	_	_	-
	105	STORAGE 2	_	_	_	_	_	ı	-	-
	106	CONCESSIONS	_	_	_	_	_	_	-	-
										)



			FINISH SCHI	EDULE			
FINISH MARK	MATERIAL	MANUFACTURER COMPANY NAME	INFO PRODUCT NUMBER	DIMENSION	COLOR	FINISH	COMMENTS
FINICH C	OO A TIMOS						
PNT-1	COATINGS  EXTERIOR ACRYLIC URETHANE	SHERWIN WILLIAMS	_		DARK BRONZE	SEMI-GLOSS	DOODS AND EDAMES
PNT-2	ACRYLIC CMU PAINT	SHERWIN WILLIAMS	LOXON SELF-CLEANING		DNR TAN — COLOR MATCH	SATIN	DOORS, AND FRAMES  TWO (2) COATS INTERIOR RESTR
FINI-Z	ACKTEIC CMO FAINT	SHERWIN WILLIAMS	LOADIN SELI -CLEANING	_	DNK TAN - COLOR MATCH	SATIN	TWO (2) COATS INTERIOR RESTR
COUNTER	RTOP MATERIAL						
QC-1	ZODIAQ	DUPONT	-	3CM THICK	GRAPHITE	POLISHED	MATCH EXISTING COUNTERTOP DIMENSI
FYTERIO	R FINISH						
SS-1	STEEL SOFFIT PANEL	<del>-</del>	V-GROOVE VENTED	26GA	DARK BRONZE	_	ALL EAVES AND OVERHANGS
SF-1	STEEL FASCIA WRAP		COIL STEEL WRAP	26GA	DARK BRONZE	_	CONTINUOUSLY WRAP ALL 2X FA
	CMU SEALER AND ANTI-GRAFFITI	RAINGUARD	MIRCO SEAL W/ GRAFFITI	_	CLEAR	_	ENTIRE EXTERIOR OF CMU SURFA
			·				

23-04-78-02

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$\bigcap_{1}$	INTERIOR	SECTION	_	<u>RESTROOMS</u>
$\bigcup$	SCALE: $1/2" = 1$	·-0"		

### KEYNOTES TOILET ACCESSORY SCHEDULE GENERAL NOTES FIELD VERIFY ALL DIMENSIONS PRIOR TO CONSTRUCTION. ALL MODEL NUMBERS BASED ON BOBRICK WASHROOM EQUIPMENT UNLESS OTHERWISE NOTED. 10. PRESSURE WASH ENTIRE EXTERIOR BUILDING WITH DE-GREASING DETERGENT, CLEAN WITH STIFF NYLON 17. OVERHEAD COILING DOOR, 22GA GALVANIZED STEEL, 1 ½" X ½" FLAT STEEL SLAT. DOOR TO BE QUARTZ COUNTERTOP (QC-1) OR APPROVED EQUAL, OVER $\frac{3}{4}$ " PLYWOOD WITH 4" VALENCE AND 4" CLEAN CONSTRUCTION AREA THOROUGHLY, INTERIOR AND EXTERIOR, WHEN PROJECT IS COMPLETED. NO. BY REVISION BRUSHES. ALLOW TO DRY FOR TWO (2) DAYS, THEN COAT ENTIRE EXTERIOR OF BUILDING WITH T-1) SURFACE-MOUNTED MULTI-ROLL TOILET PAPER DISPENSER B-274 BACKSPLASH, REUSE EXISTING ANGLE SUPPORTS, OR APPROVED EQUAL. REFER TO DETAIL 03/A-100. LOCKABLE FROM THE EXTERIOR. HOOD TO BE 24GA STEEL, MOUNT DOOR TO INTERIOR OF EXISTING REFER TO SITE PLAN FOR MORE INFORMATION. MICRO-SEAL WITH ANTI-GRAFFITI CMU BLOCK SEALER, FOLLOWING MANUFACTURER'S APPLICATION 2. ADA URINAL - AMERICAN STANDARD 0.5 GPF MANUAL ADA URINAL (6561.017), MOUNT SO RIM OF CMU JAMB, MANUAL CRANK OPERATION, COLOR TO BE DARK BRONZE, FIELD VERIFY DIMENSIONS. ALL ELECTRICAL TO BE STATE ELECTRICAL CODE COMPLIANT PER IOWA ADMINISTRATIVE RULE INSTRUCTIONS. 18. REMOVE DOORS, CLEAN DOORS AND FRAMES THOROUGHLY, PAINT WITH TWO (2) COATS OF PNT-1. URINAL IS 17" ABOVE FINISH FLOOR. ADD SLOAN ROYAL 186 FLUSH VALVE WITH MANUAL LEVER AND CHAPTER 661-504. T-2) CONCEALED MOUNTING WITH SNAP FLANGE GRAB BARS B-6806 x 42 11. ADA RESTROOM SIGNS, BLACK BACKGROUND, WHITE LETTERING AND GRAPHICS, WITH BRAILLE, PROVIDE 19. EXISTING WALL HUNG TOILET TO REMAIN, PROTECT IN PLACE. ALL ACCESSORIES. ALL PLUMBING TO BE STATE PLUMBING CODE COMPLIANT PER IOWA ADMINISTRATIVE RULE CHAPTER ONE WOMEN'S AND ONE MEN'S SIGN THE DOORS. MOUNT SO BRAILLE IS NO HIGHER THAN 48" FROM 20. REINSTALL EXISTING ELECTRICAL BACK-BOX, DUPLEX OUTLET, AND FACEPLATE. REWIRE TO SWITCH TO 641-25. HAND-DRYER BY EXCEL, OR APPROVED EQUAL (XL-GR-110-120V). INSTALL INTO EXISTING T-3) CONCEALED MOUNTING WITH SNAP FLANGE GRAB BARS B-6806 x 36 ENSURE CODE COMPLIANT INSTALLATION. THE FINISH FLOOR. COMPLIANCE SIGNS RRE-125 AND RRE-145 OR APPROVED EQUAL. ELECTRICAL J-BOX. CONTRACTOR TO RUN NEW ELECTRICAL LINE TO PANEL IF NOT PROVIDED. PRESSURE WASH INTERIOR OF RESTROOMS (WOMEN 101 AND MEN 103) WITH DE-GREASING DETERGENT, 12. 26 GAUGE, VENTED, STEEL SOFFIT PANEL, DARK BRONZE TO MATCH FASCIA AND GUTTERS. CONTRACTOR TO PROVIDE "J" AND "T" TRIM WHERE NECESSARY SO RAW EDGES ARE NOT EXPOSED. CLEAN WITH STIFF NYLON BRUSHES. ALLOW TO DRY, THE PAINT TWO (2) COATS OF PNT-2. 13. SAND-BLAST AND POWDER-COAT LIGHT POLE AND BASE COVER, DARK BRONZE. REINSTALL POLE AND 5. LAVATORY FAUCET AND TRIM PACKAGE BY CHICAGO FAUCETS: 3400-TA-BCP, STRAINER DRAIN WITH (T-5) KOALA KARE HORIZONTAL WALL-MOUNTED BABY CHANGING STATION KB300 (GREY 01) BASE WITH ONE (1) NEW HUBBLE VSP-48L-110-4K7-4-UNV-AD-DB LIGHT HEAD EACH, FOR A TOTAL DRAWN BY: PROJECT NUMBER: SCALD GUARDS ON P-TRAP PIPING. OF FOUR (4) LIGHT HEADS. 6. ADA COMPLIANT, 19 $\frac{1}{4}$ " OVAL LAVATORY SINK BOWL BY KOHLER (CAXTON K-2210-0 WHITE), OR 14. MONOLITHIC QUARTZ COUNTERTOP (QC-1), MATCH EXISTING COUNTERTOP DIMENSIONS, 3" DIAMETER APPROVED EQUÁL. INCLUDE P-TRAP, SCALD-GUARDS, AND STRÀINER DRAIN. CHK'D BY: DATE: ROUNDED ON LOBBY FACING SIDE, ALL EDGES TO BE EASED. 6" GUTTER AND DOWNSPOUT WITH SHUR-FLO GUTTER GUARDS, CONTINUOUS OR APPROVED EQUAL, 15. BRADMAR SENTINAL 400 SERIES TOILET PARTITIONS, OVERHEAD BRACED, OR APPROVED EQUAL. FOLLOW EXISTING LAYOUT OF PARTITIONS, SPACE EQUALLY BETWEEN TOILET COMPARTMENTS, ENSURE A 8. COOPER LIGHTING METALUX 4SWLED-28SL-LW-UNV-L840-CD-1, OR APPROVED EQUAL. INSTALL A MINIMUM 5'-6" OF SPACE IN THE ADA COMPARTMENT. COLOR TO BE S200 GRAY. ADA STALL WALL NEW LIGHT FIXTURE AT ALL EXISTING LOCATIONS IN RESTROOMS, SURFACE MOUNT. BRACING NEEDS TO BE EXTENDED HIGH ENOUGH TO BE ATTACHED TO MASONRY ABOVE THE WINDOWS. PRESSURE TREATED 2X10 FASCIA, MATCH EXISTING DIMENSIONS, WRAP FASCIA IN BREAK METAL, DARK 16. BRADMAR SENTINAL 400 SERIES URINAL SCREEN, OR APPROVED EQUAL, COLOR TO BE S200 GRAY. BRONZE.